


QUEEN OF PEACE CATHOLIC PARISH
LOT 1, BLOCK 13, AURORA HILLS, FILING NO. 9,
CITY OF AURORA, ARAPAHOE COUNTY, STATE OF COLORADO.
RECEPTION NO. 933522 RECORDED ON OCTOBER 16 1964.

MAJOR SITE PLAN AMENDMENT

VICINITY MAP

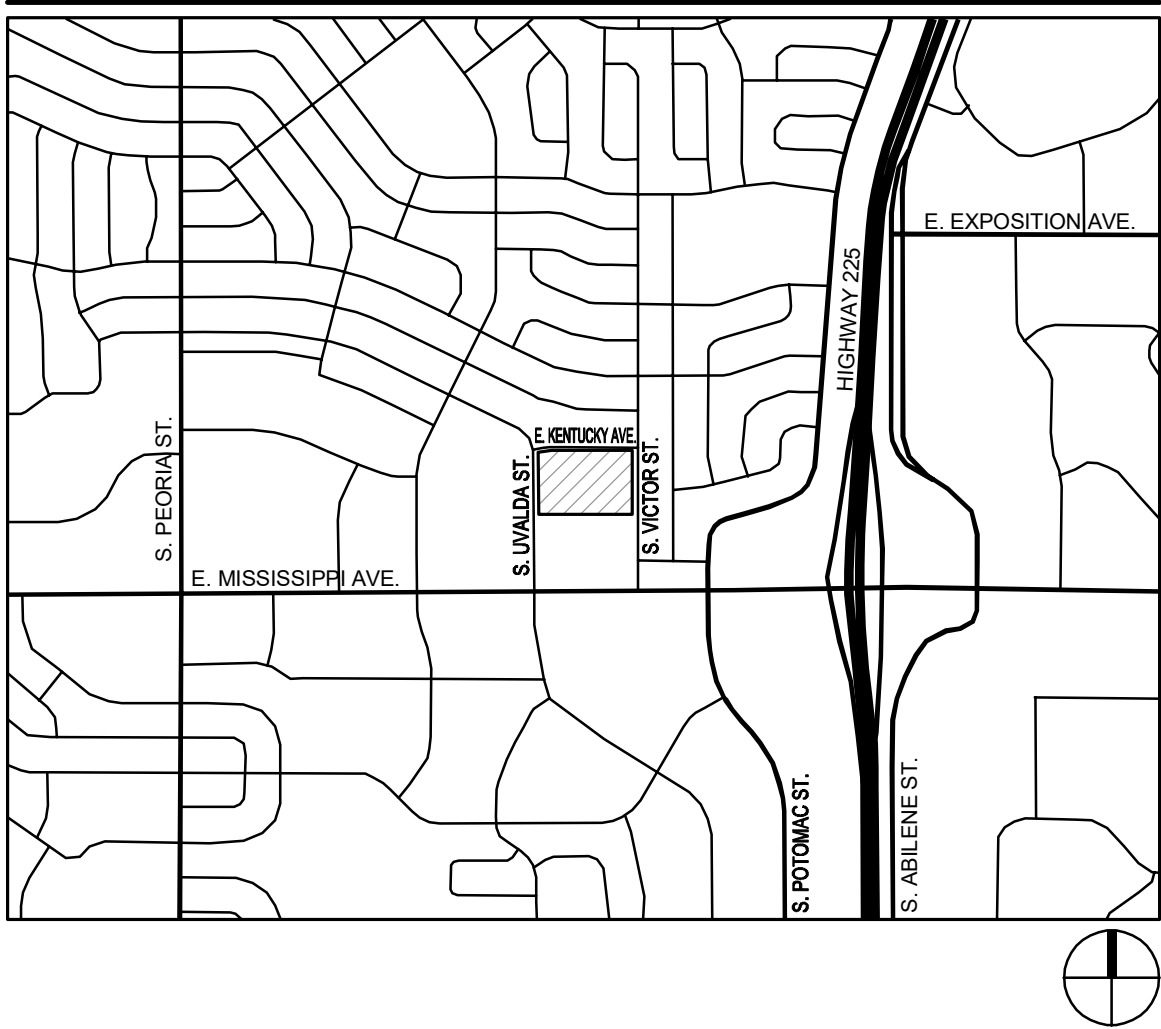

The site plan will not be approved by public works until the preliminary drainage letter/report is approved

Duly Noted. SDA submitted the preliminary drainage report and awaiting signatures for the Final Drainage Report.

DEVELOPMENT TEAM CONTACTS:

OWNER / DEVELOPER

ARCHDIOCESE OF DENVER
1300 SOUTH STEELE STREET
DENVER, COLORADO 80210
PH: (303) 364-1056
CONTACT: DENNIS HABERKORN
EMAIL: dennis.haberkorn@queenofpeace.net

SURVEYOR

PRECISION SURVEY & MAPPING, INC.
9025 E. KENYON AVE., SUITE 150
DENVER, CO 80237
PH: (303) 753-9799
CONTACT: CHRISTOPHER P. JULIANA, PLS
E-MAIL: cjuliana@precision-survey.com

ARCHITECT

INTEGRATION DESIGN GROUP, PC
6890 W. 52ND AVE., SUITE 230
ARVADA, CO 80002
PH: (303) 227-9453
CONTACT: MR. ADAM HERMANSON, AIA
adam.hermanson@integrationdesigngroup.com

CIVIL ENGINEER

STERLING DESIGN ASSOCIATES, LLC
2009 W. LITTLETON BLVD., #300
LITTLETON, CO 80120
PH: (303) 794-4727
CONTACT: JAY M. NEWELL, P.E.
E-MAIL: jay@sterlingdesignassociates.com

LANDSCAPE ARCHITECT

STERLING DESIGN ASSOCIATES, LLC
2009 W. LITTLETON BLVD., #300
LITTLETON, CO 80120
PH: (303) 794-4727
CONTACT: JOSEPH WILSON, RLA, CID
E-MAIL: joe@sterlingdesignassociates.com

LEGAL DESCRIPTION

LOT ONE BLOCK 13, AURORA HILLS, FILING NO. 9, CITY OF AURORA, ARAPAHOE COUNTY, STATE OF COLORADO - RECEPTION NO. 933522 RECORDED ON OCTOBER 16, 1964.

PROJECT NOTE

THE FOLLOWING MAJOR SITE PLAN AMENDMENT IS A SUPPLEMENTAL PROJECT SUBMITTAL TO THE APPROVED SITE DEVELOPMENT PLAN DATED 06/02/1998. ALL REFERENCES TO THE "PREVIOUSLY APPROVED SITE DEVELOPMENT PLAN" SHALL REFERENCE THIS 06/02/1998 SET.

SITE PLAN NOTES:

- THE DEVELOPER, HIS SUCCESSORS AND ASSIGNS, INCLUDING THE HOMEOWNERS OR MERCHANTS ASSOCIATION, SHALL BE RESPONSIBLE FOR INSTALLATION, MAINTENANCE AND REPLACEMENT OF ALL FIRE LANE SIGNS AS REQUIRED BY THE CITY OF AURORA.
- ALL SIGNS MUST CONFORM TO THE CITY OF AURORA SIGN CODE.
- RIGHT OF WAY FOR INGRESS AND EGRESS FOR SERVICE AND EMERGENCY VEHICLES IS GRANTED OVER, ACROSS, ON AND THROUGH ANY AND ALL PRIVATE ROADS AND WAYS NOW OR HEREAFTER ESTABLISHED ON THE DESCRIBED PROPERTY, AND THE SAME ARE HEREBY DESIGNATED AS "SERVICE/EMERGENCY AND UTILITY EASEMENTS" AND SHALL BE POSTED "NO PARKING - FIRE LANE."
- "ACCESSIBLE EXTERIOR ROUTES" SHALL BE PROVIDED FROM PUBLIC TRANSPORTATION STOPS, ACCESSIBLE PARKING AND ACCESSIBLE PASSENGER LOADING ZONES AND PUBLIC SIDEWALKS TO 60% OF THE ACCESSIBLE BUILDING ENTRANCES THEY SERVE. THE ACCESSIBLE ROUTE BETWEEN ACCESSIBLE PARKING AND ACCESSIBLE BUILDING ENTRANCES SHALL BE THE MOST PRACTICAL DIRECT ROUTE. THE ACCESSIBLE ROUTE MUST BE LOCATED WITHIN A SIDEWALK. NO SLOPE ALONG THIS ROUTE MAY EXCEED 1:20 WITHOUT PROVIDING A RAMP WITH A MAXIMUM SLOPE OF 1:12 AND HANDRAILS. CROSSWALKS ALONG THIS ROUTE SHALL BE WIDE ENOUGH TO WHOLLY CONTAIN THE CURB RAMP WITH A MINIMUM WIDTH OF 36" AND SHALL BE PAINTED WITH WHITE STRIPES. THE CITY OF AURORA ENFORCES HANDICAPPED ACCESSIBILITY REQUIREMENTS BASED ON THE 2015 INTERNATIONAL BUILDING CODE, CHAPTER 11, AND THE INTERNATIONAL CODE COUNCIL (ICC) A117.1-2009.
- THE APPLICANT HAS THE OBLIGATION TO COMPLY WITH ALL APPLICABLE REQUIREMENTS OF THE AMERICANS WITH DISABILITIES ACT.
- THE DEVELOPER, HIS SUCCESSORS AND ASSIGNS, SHALL BE RESPONSIBLE FOR INSTALLATION, MAINTENANCE AND REPLACEMENT OF ALL LANDSCAPING MATERIALS SHOWN OR INDICATED ON THE APPROVED SITE PLAN OR LANDSCAPE PLAN ON FILE IN THE PLANNING DEPARTMENT. ALL LANDSCAPING WILL BE INSTALLED PRIOR TO ISSUANCE OF CERTIFICATE OF OCCUPANCY.
- ALL CROSSINGS AND ENCROACHMENTS BY PRIVATE LANDSCAPE IRRIGATION SYSTEMS OR PRIVATE UTILITIES INTO EASEMENTS AND STREET RIGHTS-OF-WAY OWNED BY THE CITY OF AURORA ARE ACKNOWLEDGED BY THE UNDERSIGNED AS BEING SUBJECT TO CITY OF AURORA'S USE AND OCCUPANCY OF THE SAID EASEMENTS OR RIGHTS-OF-WAY. THE UNDERSIGNED, THEIR SUCCESSORS AND ASSIGNS, HEREBY AGREE TO INDEMNIFY THE CITY OF AURORA FOR ANY LOSS, DAMAGE, OR REPAIR TO CITY FACILITIES THAT MAY RESULT FROM THE INSTALLATION, OPERATION OR MAINTENANCE OF SAID PRIVATE IRRIGATION SYSTEMS OR PRIVATE UTILITIES.
- THE APPROVAL OF THIS DOCUMENT DOES NOT CONSTITUTE FINAL APPROVAL OF GRADING, DRAINAGE, UTILITY, PUBLIC IMPROVEMENTS AND BUILDING PLANS. CONSTRUCTION PLANS MUST BE REVIEWED AND APPROVED BY THE APPROPRIATE AGENCY PRIOR TO THE ISSUANCE OF BUILDING PERMITS.
- ALL BUILDING ADDRESS NUMBERS SHALL COMPLY WITH THE AURORA CITY CODE, ARTICLE VII-NUMBERING OF BUILDINGS.
- ALL ROOFTOP MECHANICAL EQUIPMENT AND VENTS GREATER THAN EIGHT (8) INCHES IN DIAMETER MUST BE SCREENED. SCREENING MAY BE DONE EITHER WITH AN EXTENDED PARAPET WALL OR A FREESTANDING SCREEN WALL. SCREENS SHALL BE AT LEAST AS HIGH AS THE EQUIPMENT THEY HIDE. IF EQUIPMENT IS VISIBLE BECAUSE SCREENS DON'T MEET THIS MINIMUM HEIGHT REQUIREMENT, THE DIRECTOR OF PLANNING MAY REQUIRE CONSTRUCTION MODIFICATIONS PRIOR TO THE ISSUANCE OF A PERMANENT CERTIFICATE OF OCCUPANCY.
- NOTWITHSTANDING ANY SURFACE IMPROVEMENTS, LANDSCAPING, PLANTING OR CHANGES SHOWN IN THESE SITE OR CONSTRUCTION PLANS, OR ACTUALLY CONSTRUCTED OR PUT IN PLACE, ALL UTILITY EASEMENTS MUST REMAIN UNOBSTRUCTED AND FULLY ACCESSIBLE ALONG THEIR ENTIRE LENGTH TO ALLOW FOR ADEQUATE MAINTENANCE EQUIPMENT. ADDITIONALLY, NO INSTALLATION, PLANTING, CHANGE IN THE SURFACE, ETC., SHALL INTERFERE WITH THE OPERATION OF THE UTILITY LINES PLACED WITHIN THE EASEMENT. BY SUBMITTING THESE SITE OR CONSTRUCTION PLANS FOR APPROVAL, THE LANDOWNER RECOGNIZES AND ACCEPTS THE TERMS, CONDITIONS AND REQUIREMENTS OF THIS NOTE.
- FINAL GRADE SHALL BE AT LEAST SIX (6) INCHES BELOW ANY EXTERIOR WOOD SIDING ON THE PREMISES.
- ALL INTERESTED PARTIES ARE HEREBY ALERTED THAT THIS SITE PLAN IS SUBJECT TO ADMINISTRATIVE CHANGES AND AS SHOWN ON THE ORIGINAL SITE PLAN ON FILE IN THE AURORA CITY PLANNING OFFICE AT THE MUNICIPAL BUILDING. A COPY OF THE OFFICIAL CURRENT PLAN MAY BE PURCHASED THERE. LIKEWISE, SITE PLANS ARE REQUIRED TO AGREE WITH THE APPROVED SUBDIVISION PLAT OF RECORD AT THE TIME OF A BUILDING PERMIT; AND IF NOT, MUST BE AMENDED TO AGREE WITH THE PLAT AS NEEDED, OR VICE VERSA.
- ERRORS IN APPROVED SITE PLANS RESULTING FROM COMPUTATIONS OR INCONSISTENCIES IN THE DRAWINGS MADE BY THE APPLICANT ARE THE RESPONSIBILITY OF THE PROPERTY OWNER OF RECORD. WHERE FOUND, THE CURRENT MINIMUM CODE REQUIREMENTS WILL APPLY AT THE TIME OF BUILDING PERMIT. PLEASE BE SURE THAT ALL PLAN COMPUTATIONS ARE CORRECT.
- ALL REPRESENTATIONS AND COMMITMENTS MADE BY APPLICANTS AND PROPERTY OWNERS AT PUBLIC HEARINGS REGARDING THIS PLAN ARE BINDING UPON THE APPLICANT, PROPERTY OWNER, AND ITS HEIRS, SUCCESSORS, AND ASSIGNS.
- ARCHITECTURAL FEATURES, SUCH AS BAY WINDOWS, FIREPLACES, ROOF OVERHANGS, GUTTERS, EAVES, FOUNDATIONS, FOOTINGS, CANTILEVERED WALLS, ETC., ARE NOT ALLOWED TO ENCROACH INTO ANY EASEMENT OR FIRE LANE.
- THERE WILL BE NO OUTSIDE, OVERNIGHT STORAGE OF VEHICLES ON THE SITE.
- THE 2015 INTERNATIONAL FIRE CODE (IFC), REQUIRES ALL BUILDINGS TO BE ASSESSED FOR ADEQUATE EMERGENCY RESPONDER RADIO COVERAGE (ERRC). AT THE TIME THE STRUCTURE IS AT FINAL FRAME AND FINAL ELECTRICAL INSPECTIONS, THE GENERAL CONTRACTOR (GC) WILL BE REQUIRED TO HIRE A QUALIFIED INDEPENDENT 3RD PARTY TO ASSESS THE RADIO FREQUENCY LEVELS WITHIN THE STRUCTURE. ONCE COMPLETED, THE 3RD PARTY WILL PROVIDE THE RESULTS OF THE TEST TO BOTH THE GC AND THE AURORA BUILDING DIVISION AS TO WHETHER THE STRUCTURE PASSED OR FAILED THE PRELIMINARY RADIO SURVEILLANCE. A STRUCTURE THAT HAS PASSED THIS SURVEILLANCE REQUIRES NO FURTHER ACTION BY THE GC. A FAILED RADIO SURVEILLANCE WILL REQUIRE A LICENSED CONTRACTOR TO SUBMIT PLANS TO THE AURORA BUILDING DIVISION TO OBTAIN A BUILDING PERMIT FOR THE INSTALLATION OF AN ERRC SYSTEM PRIOR TO INSTALLATION. THIS ASSESSMENT AND INSTALLATION IS AT THE OWNER OR DEVELOPERS EXPENSE. FUTURE INTERIOR OR EXTERIOR MODIFICATIONS TO THE STRUCTURE AFTER THE ORIGINAL CERTIFICATE OF OCCUPANCY IS ISSUED WILL REQUIRE A REASSESSMENT FOR ADEQUATE RADIO FREQUENCY COVERAGE.
- THE DEVELOPER IS REQUIRED TO INSTALL STOP SIGNS AND STREET NAME SIGNS AT THE SITE ACCESS POINTS ONTO PUBLIC STREETS. SIGNS SHALL BE FURNISHED AND INSTALLED PER THE MOST CURRENT EDITIONS OF THE MANUAL ON UNIFORM TRAFFIC CONTROL DEVICES (MUTCD) AND CITY STANDARDS.

SHEET INDEX:

- COVER SHEET
- SITE PLAN
- GRADING PLAN
- UTILITY PLAN
- TREE PROTECTION & MITIGATION PLAN
- LANDSCAPE PLAN
- LANDSCAPE NOTES AND DETAILS
- BUILDING ELEVATIONS

All crossings or encroachments into easements and rights-of-way owned by the City of Aurora ("City") identified as being privately-owned and maintained herein are acknowledged by the undersigned as being subject to City's use and occupancy of said easements or rights-of-way. The undersigned, its successors and assigns, further agrees to remove, repair, replace, relocate, modify, or otherwise adjust said crossings or encroachments upon request from the City and at no expense to the City. The City reserves the right to make full use of the easements and rights-of-way as may be necessary or convenient and the City retains all rights to operate, maintain, install, repair, remove or relocate any City facilities located within said easements and rights-of-way at any time and in such a manner as it deems necessary or convenient.

Note #7 has been revised.

SITE DATA CHART

	EXISTING CONDITIONS	PROPOSED CONDITIONS
OVERALL LAND AREA	8.02 ACRES (349,463 SF)	-
NUMBER OF BUILDINGS	1	-
BUILDING HEIGHT	147'-9"	197'-7" (HT. OF TALLEST PROPOSED ARCHITECTURAL ELEMENT)
HT. OF TALLEST PROPOSED ARCHITECTURAL ELEMENT	197'-7"	-
CONSTRUCTION TYPE	-	VB "2015 IBC"
OCCUPANCY CLASSIFICATION	-	A3 "2015 IBC"
TOTAL BUILDING COVERAGE AND GFA (FIRST FLOOR)	EX. BUILDING = 25,940 SF	BLDG EXPANSION= 21,343 SF = 0.13 FAR (14%)
HARD SURFACE AREA	-	176,003 SF (50%)
LANDSCAPE AREA	-	126,177 SF (36%)
PRESENT ZONING CLASSIFICATION	R-1	-
ALLOWABLE SIGN AREA	EXISTING TO REMAIN	(2) FREESTANDING SIGNS. BOTH SIGNS ARE 53" X 53".
NUMBER OF SIGNS	2 (EXISTING TO REMAIN)	0
PARKING SPACES	345 (1,378 CHURCH SEATING)	362 EXISTING TO REMAIN
ACCESSIBLE SPACES	8 SPACES	19 COMPLIANT SPACES + 22 SPACES RESERVED FOR HC PARKING
VAN ACCESSIBLE SPACES	-	1 SPACE
LOADING SPACES REQUIRED	-	1 EXISTING TO REMAIN
BICYCLE PARKING REQUIRED	10 SPACES REQUIRED	10 SPACES PROVIDED

Please update all of the height figures here to reflect the height of the building from the finished grade. The finished grade plus 100 feet is confusing and misleading. Do this for all building elevations as well

The elevation numbers have been updated to 0 for baseline height.



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NO.: 2	DATE: 06/14/2019	BY: JLW	
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NO.: 5	DATE: -	BY: -	
DESCRIPTION: -			
NO.: 6	DATE: -	BY: -	
DESCRIPTION: -			
DATE: FEBRUARY 2019			
SCALE: -			
PROJECT MANAGER: JLW		PROJECT NO.: -	
DRAWN BY: JLW		DRAWING FILE: -	

PROJECT:
**QUEEN OF PEACE
CATHOLIC PARISH
13120 EAST KENTUCKY AVENUE
AURORA, CO 80012**

CLIENT:
ARCHDIOCESE OF DENVER
1300 S STEELE STREET
DENVER, CO 80210

TEL: (303) 722-4687

SHEET TITLE:
COVER SHEET

SHEET NUMBER:

1 OF 8

LOT 1, BLOCK 13, AURORA HILLS, FILING NO. 9,
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RECEPTION NO. 933522 RECORDED ON OCTOBER 16 1964.

The process with Easement Dedication has started with Andy Niquette. The process of releasing the easement on the building into the building has started with Xcel Energy.



	PROPERTY LINE
	ADJACENT LOT LINE
	EXISTING EASEMENT
	PROPOSED EASEMENT
	EXISTING CONCRETE
	EXISTING BUILDING
	EXISTING CURB & GUTTER
	CONCRETE PAVEMENT
	PROPOSED SIDEWALK
	PROPOSED CURB & GUTTER
	EXISTING FENCE
	SAWCUT LINE
LS	LANDSCAPE AREA
	EXISTING TELEPHONE PEDESTAL
	EXISTING FIRE HYDRANT
	EXISTING CABLE TV PEDESTAL
	EXISTING ELECTRIC PEDESTAL
	EXISTING STREET LIGHTPOLE
	EXISTING LANDSCAPE LIGHT
	EXISTING SIGN
	EXISTING BOLLARD/POST
	FOUND PROPERTY CORNER
	ACCESSIBLE ROUTE
	BUILDING EXPANSION LIMITS LINE

1. REFER TO COVER SHEET FOR ADDITIONAL PROJECT GENERAL NOTES.
2. THE CONTRACTOR SHALL REFER TO THE ARCHITECTURAL PLANS FOR EXACT LOCATIONS AND DIMENSIONS OF EXIT PORCHES, RAMPS, STAIRS, PRECISE BUILDING DIMENSIONS, AND BUILDING ENTRANCES.
3. ALL PROPOSED SIGNING AND STRIPING WILL BE IN ACCORDANCE WITH THE MANUAL OF UNIFORM TRAFFIC CONTROL DEVICES (MUTCD) AND LOCAL CODES.
4. REFER TO ARCHITECTURAL PLANS FOR BUILDING SIGNAGE LOCATIONS, IF APPLICABLE.
5. ALL SITE LIGHTING IS EXISTING TO REMAIN UNLESS INDICATED ARCHITECTURAL PLANS. REFER TO ARCHITECTURAL PLANS FOR SITE ELECTRICAL INSTALLATION REQUIREMENTS INCLUDING, BUT NOT LIMITED TO LOCATION, TYPE, SIZE AND MATERIAL OF WIRING, CONDUIT, TRENCH, AND CONNECTION POINTS FOR LIGHTING, SITE SIGNAGE, AND OTHER SITE IMPROVEMENTS.
6. ALL RADIUS DIMENSIONS SHOWN ARE TO FLOWLINE UNLESS OTHERWISE NOTED.
7. CONTRACTOR SHALL COORDINATE SIGNAGE PERMIT, INSTALLATION, AND SPECIFICATIONS WITH CONSTRUCTION MANAGER, IF APPLICABLE.
8. ILLUMINATION WITHIN THE SITE MUST COMPLY WITH THE 2015 INTERNATIONAL BUILDING CODE REQUIREMENT FROM SECTION 1006 - MEANS OF EGRESS ILLUMINATION, SECTION 1006. ILLUMINATION REQUIRED: THE MEANS OF EGRESS, INCLUDING THE EXIT DISCHARGE, SHALL BE ILLUMINATED AT ALL TIMES THE BUILDING IS OCCUPIED. SECTION 1006.2 ILLUMINATION LEVEL, THE MEANS OF EGRESS ILLUMINATION LEVEL SHALL NOT BE LESS THAN 1 FOOT-CANDLE (11 LUX) AT THE FLOOR LEVEL, AND CONTINUING TO THE "PUBLIC WAY".

2009 W. Littleton Blvd. #300
Littleton, CO 80120
303.794.4727 ph
www.SterlingDesignAssociates.com

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DESCRIPTION: -		
NO: 6	DATE: -	BY: -
DESCRIPTION: -		

DATE: FEBRUARY 2019	SCALE: 1"=30'
PROJECT MANAGER: JLW	PROJECT NO.: -
DRAWN BY: JLW	DRAWING FILE: -

PROJECT:

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13120 EAST KENTUCKY AVENUE
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1300 S STEELE STREET
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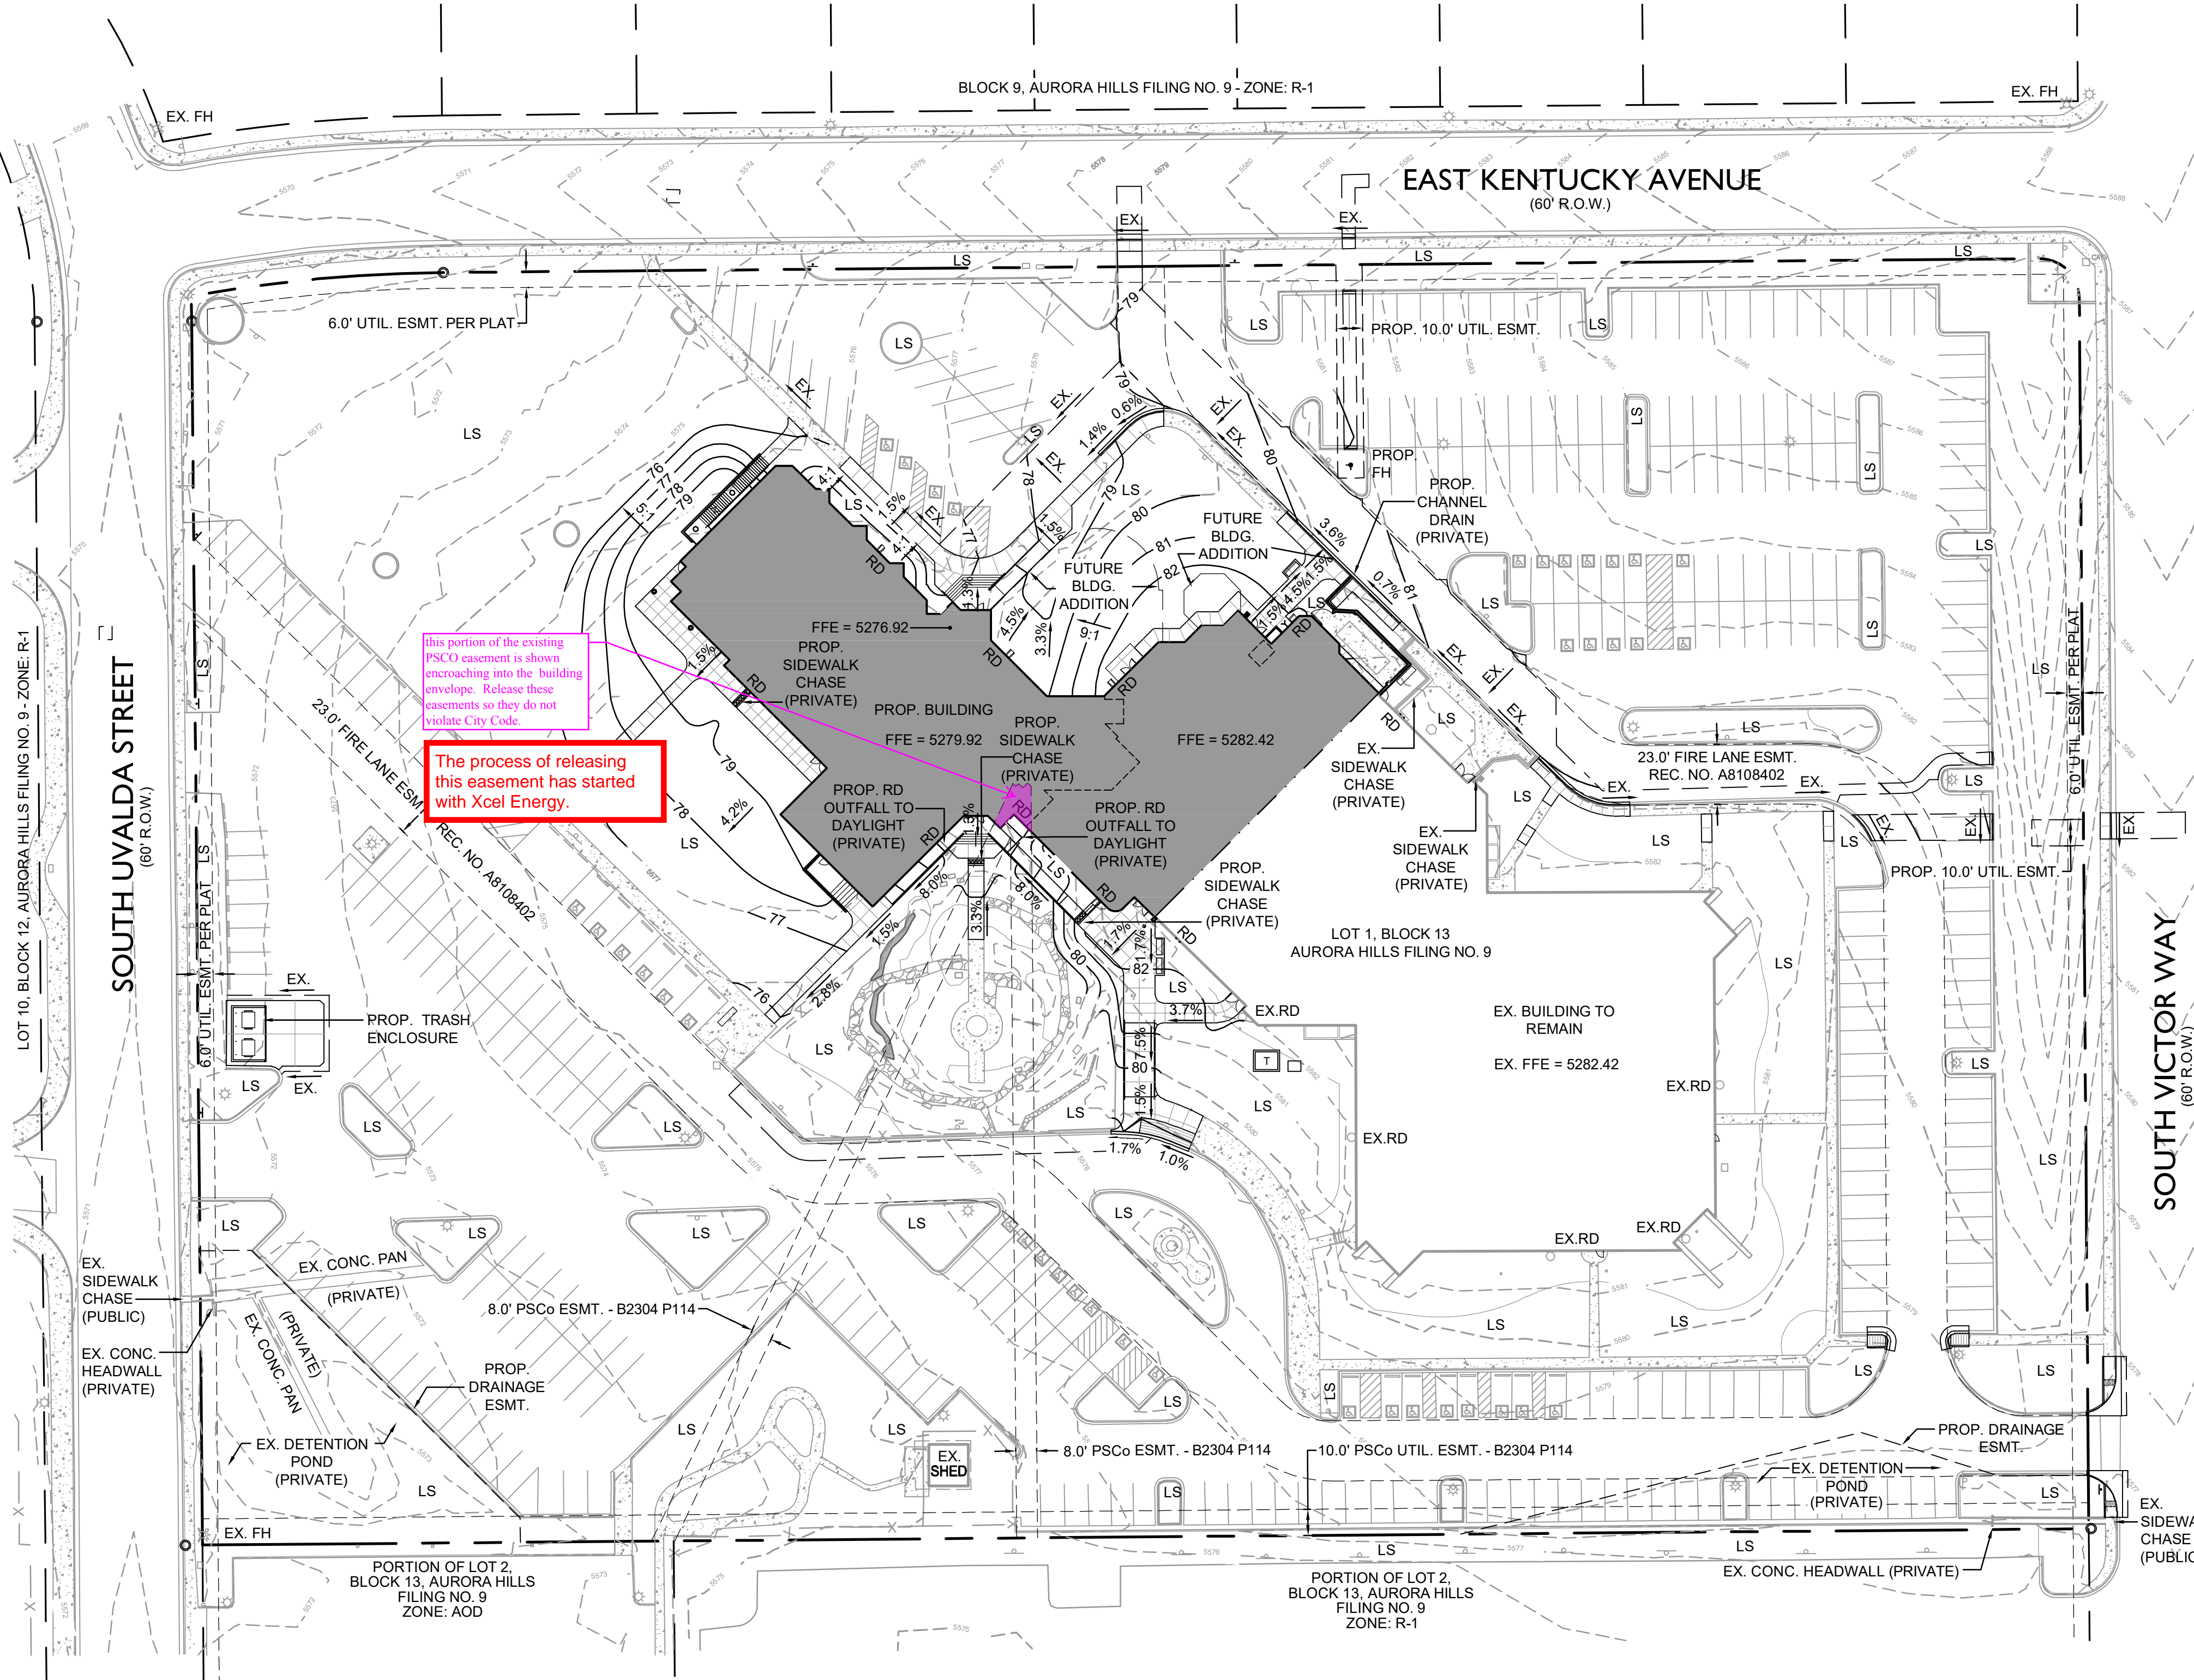
SHEET TITLE:

SITE PLAN

SHEET NUMBER:

2 OF 8

QUEEN OF PEACE CATHOLIC PARISH
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MAJOR SITE PLAN AMENDMENT



LEGEND

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	PROPOSED EASEMENT
	EXISTING CONCRETE
	EXISTING BUILDING
	EXISTING CURB & GUTTER
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	PROPOSED CURB & GUTTER
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	SAWCUT LINE
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	EXISTING MINOR CONTOUR
	PROPOSED MAJOR CONTOUR
	PROPOSED MINOR CONTOUR
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	EXISTING CABLE TV PEDESTAL
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Sterling Design Associates, LLC
CIVIL ENGINEERS - LANDSCAPE ARCHITECTS

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FEBRUARY 2019	1"=20'
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JLW	-
DRAWN BY:	DRAWING FILE:
CL	-

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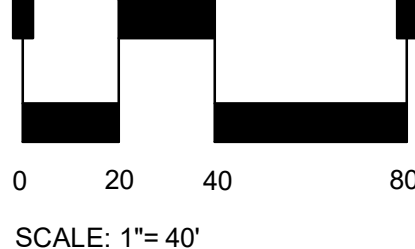
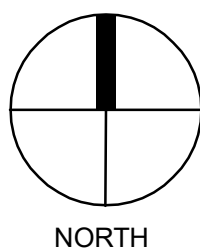
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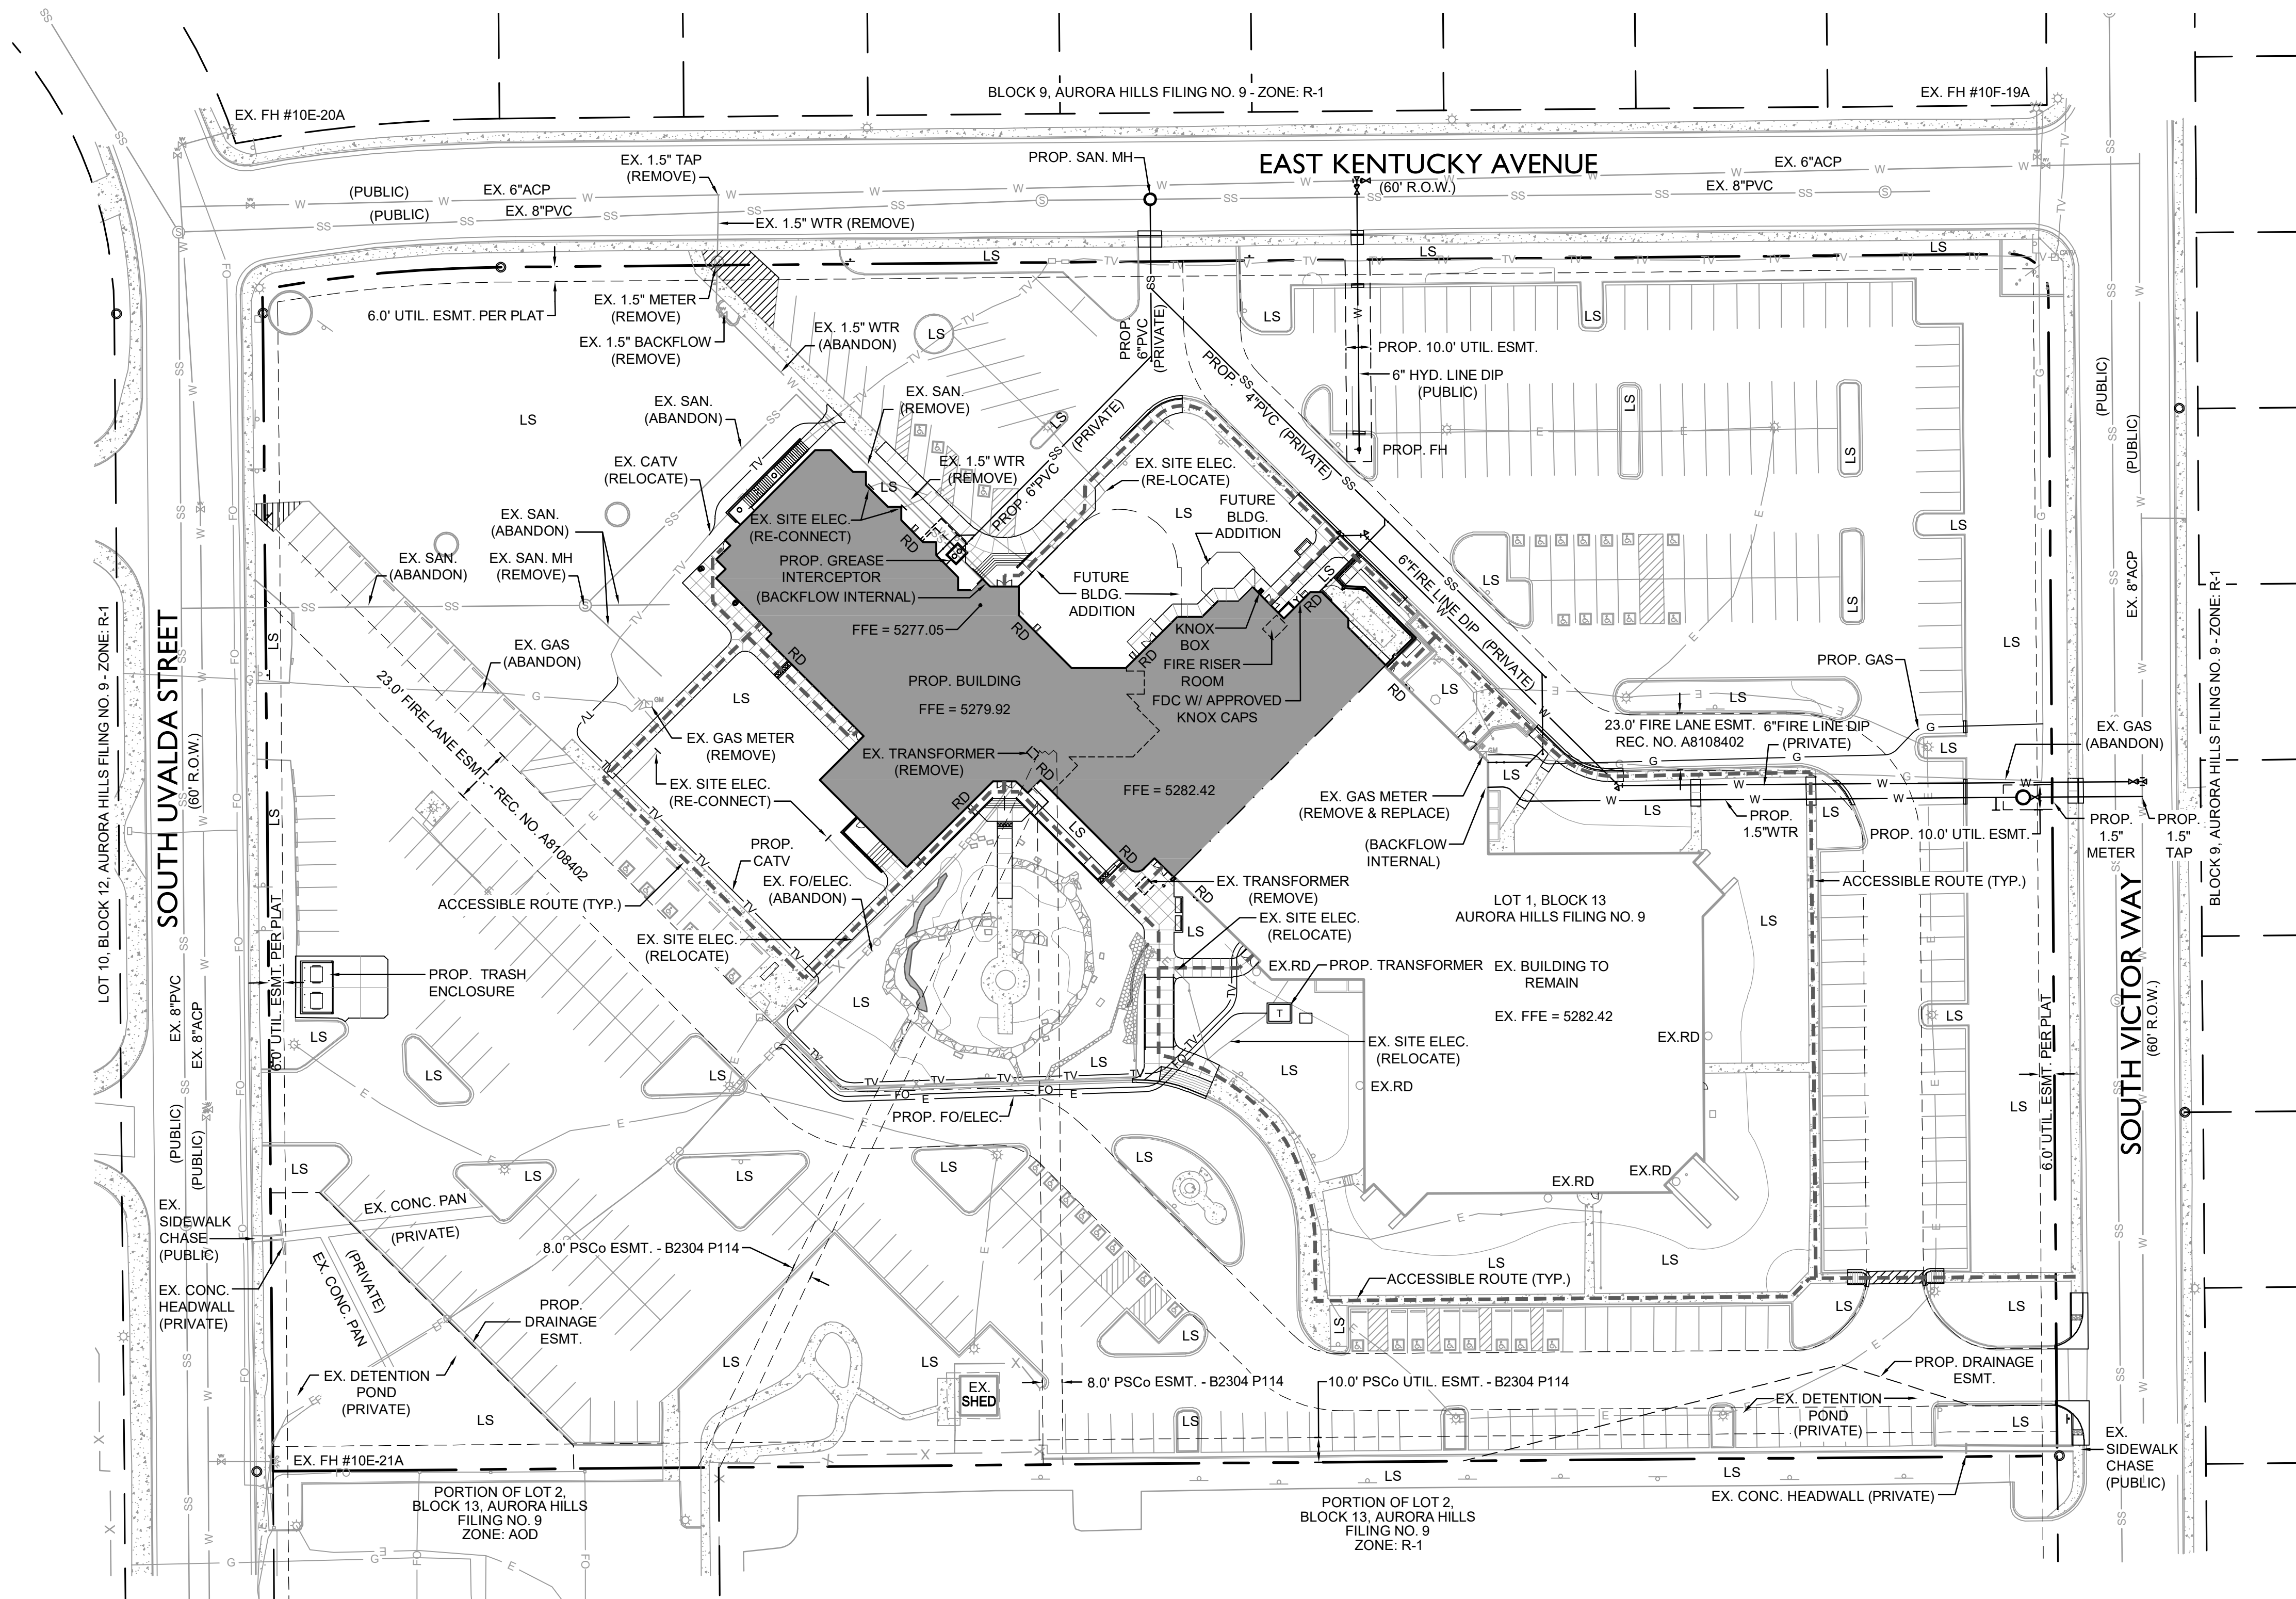
SHEET TITLE:
GRADING PLAN

SHEET NUMBER:

3 OF 8



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MAJOR SITE PLAN AMENDMENT



LEGEND

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	EXISTING PARKING STRIPING
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	PROPOSED CURB & GUTTER
	EXISTING FENCE
	LANDSCAPE AREA
	EXISTING ELECTRIC LINE
	PROPOSED ELECTRIC LINE
	EXISTING TELEPHONE LINE
	PROPOSED TELEPHONE LINE
	EXISTING GAS LINE
	PROPOSED GAS LINE
	EXISTING FIBER OPTIC LINE
	PROPOSED FIBER OPTIC LINE
	EXISTING COMMUNICATIONS LINE
	PROPOSED COMMUNICATIONS LINE
	EXISTING WATER LINE
	PROPOSED WATER LINE
	EXISTING SANITARY SEWER
	PROPOSED SANITARY SEWER
	EXISTING WATER VALVE
	EXISTING WATER METER
	EXISTING ELECTRIC HANDHOLE
	EXISTING TELEPHONE PEDESTAL
	EXISTING GAS METER
	EXISTING SEWER MANHOLE
	EXISTING FIRE HYDRANT
	EXISTING CABLE TV PEDESTAL
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FEBRUARY 2019	1"=20'
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JLW	-
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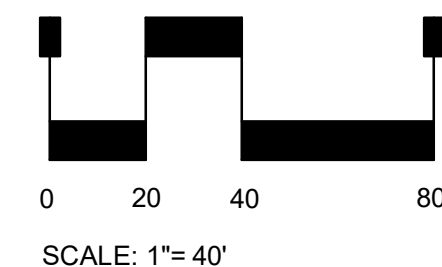
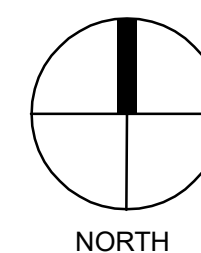
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TEL: (303) 722-4687

SHEET TITLE:
UTILITY PLAN

SHEET NUMBER:
4 OF 8



LOT 1, BLOCK 13, AURORA HILLS FILING NO. 9

PROPOSED ADDITION

FUTURE BLDG. ADDITION

EXISTING SIGN TO REMAIN

EXISTING MONUMENT TO REMAIN

MISSING DECIDUOUS OVERSTORY TREE EQUIVALENT FROM PREVIOUSLY APPROVED CITY LANDSCAPE PLAN TO BE REPLANTED ELSEWHERE ON SITE

#1- (1) EXISTING BLUE SPRUCE TREE TO BE REMOVED

MISSING DECIDUOUS OVERSTORY TREE EQUIVALENT FROM PREVIOUSLY APPROVED CITY LANDSCAPE PLAN TO BE REPLANTED ELSEWHERE ON SITE

23.0' FIRE LANE ESMT. REC. NO. A8108402

60' UTIL. ESMT. PER PLAT

PROP. 10.0' UTIL. ESMT.

PROP. TRASH ENCLOSURE

#9- (1) EXISTING UPRIGHT JUNIPER TO BE REMOVED

#7- (1) EXISTING JUNIPER TO BE REMOVED

#6- (1) EXISTING JUNIPER TO BE REMOVED

#5- (1) EXISTING JUNIPER TO BE REMOVED

#4- (1) EXISTING JUNIPER TO BE REMOVED

#3- (1) EXISTING JUNIPER TO BE REMOVED

#2- (1) EXISTING JUNIPER TO BE REMOVED

#10- (1) EXISTING LINDEN TREE TO BE REMOVED

#11- (1) EXISTING LINDEN TREE TO BE REMOVED

EX. BUILDING TO REMAIN

MISSING DECIDUOUS OVERSTORY TREE EQUIVALENT FROM PREVIOUSLY APPROVED CITY LANDSCAPE PLAN TO BE REPLANTED ELSEWHERE ON SITE

MISSING EVERGREEN TREE EQUIVALENT FROM PREVIOUSLY APPROVED CITY LANDSCAPE PLAN TO BE REPLANTED

8.0' PSCo ESMT. - B2304 P114

PROP. DRAINAGE ESMT.

EX. DETENTION POND

PORTION OF LOT 2, BLOCK 13, AURORA HILLS FILING NO. 9

PORTION OF LOT 2, BLOCK 13, AURORA HILLS FILING NO. 9

10.0' PSCo UTIL. ESMT. - B2304 P114

EX. SHED

8.0' PSCo ESMT. - B2304 P114

Will this tree be preserved or removed.


This tree will be removed per grading that will be required with new sidewalk configuration.

EAST KENTUCKY AVENUE

SOUTH UVALDA STREET (60' R.O.W.)

SOUTH VICTOR WAY (60' R.O.W.)

1. USE JURISDICTIONAL TREE PROTECTION NOTES (IF AVAILABLE). TREE PROTECTION NOTES BELOW SHALL BE USED FOR FURTHER INTEGRATION.	7. CONSTRUCTION VEHICLES OR MACHINERY MAY NOT PASS BETWEEN TWO OR MORE EXISTING TREES IDENTIFIED FOR PRESERVATION IF THEIR CANOPIES ARE WITHIN 10 FEET OF TOUCHING. ADDITIONAL FENCING MAY BE REQUIRED.
2. TREE PRESERVATION MEASURES MUST BE IN PLACE BEFORE CONSTRUCTION, DEMOLITION AND/OR GRADING ACTIVITIES BEGIN. IF THE JURISDICTIONAL MAY STOP CONSTRUCTION IF TREE PRESERVATION MEASURES ARE NOT IN PLACE AND MAINTAINED THROUGHOUT THE CONSTRUCTION PERIOD.	8. THE CONTRACTOR IS REQUIRED TO HAVE AN ARBORIST CERTIFIED BY THE INTERNATIONAL SOCIETY OF ARBORICULTURE (ISA) ON SITE IF SITE CONSTRUCTION EFFORTS REQUIRE REMOVAL OF EXISTING ROOTS OR BRANCH PRUNING.
3. TREES CALLED OUT FOR PRESERVATION SHALL BE FENCED AT THE DRIPLINE. FENCING MAY OCCUR AT THE COMBINED DRIPLINES OF GROUPS OF TREES. PLACE 3 INCH BARK MULCH BENEATH DRIPLINES OF TREES TO BE PRESERVED.	9. UNAUTHORIZED TREE REMOVAL OR DAMAGE IS SUBJECT TO REPLACEMENT EQUAL TO THE APPRAISED VALUE OF THE TREE LOST. CONTRACTOR IS RESPONSIBLE FOR DOCUMENTATION OF ALL EXISTING TREES TO REMAIN, PRIOR TO CONSTRUCTION.
4. FENCING SHALL BE 3 FEET TALL SNOW FENCING WITH STEEL POSTS EMBEDDED IN THE GROUND.	10. THE CONTRACTOR IS REQUIRED TO WATER, FERTILIZE AND ATTEND TO OTHER MAINTENANCE NEEDS OF EXISTING TREES TO MAINTAIN HEALTHY GROWTH THROUGHOUT THE CONSTRUCTION PERIOD. AN EARTH BERM MEASURING MINIMUM 6 FEET IN DIAMETER, AND 6 INCHES IN HEIGHT SHALL BE CONSTRUCTED AT THE BASE OF EACH TREE TO FUNCTION AS A TEMPORARY WATERING BASIN DURING THE CONSTRUCTION PERIOD. TREES SHALL BE WATERED ACCORDING TO WEATHER AND TREE SPECIES REQUIREMENTS.
5. NO GRADING SHALL OCCUR WITHIN THE DRIPLINES/FENCED AREA OF EXISTING TREES.	
6. NO CONSTRUCTION MATERIALS OR CONSTRUCTION VEHICLES MAY BE STORED WITHIN THE DRIPLINES/FENCED AREA OF EXISTING TREES.	

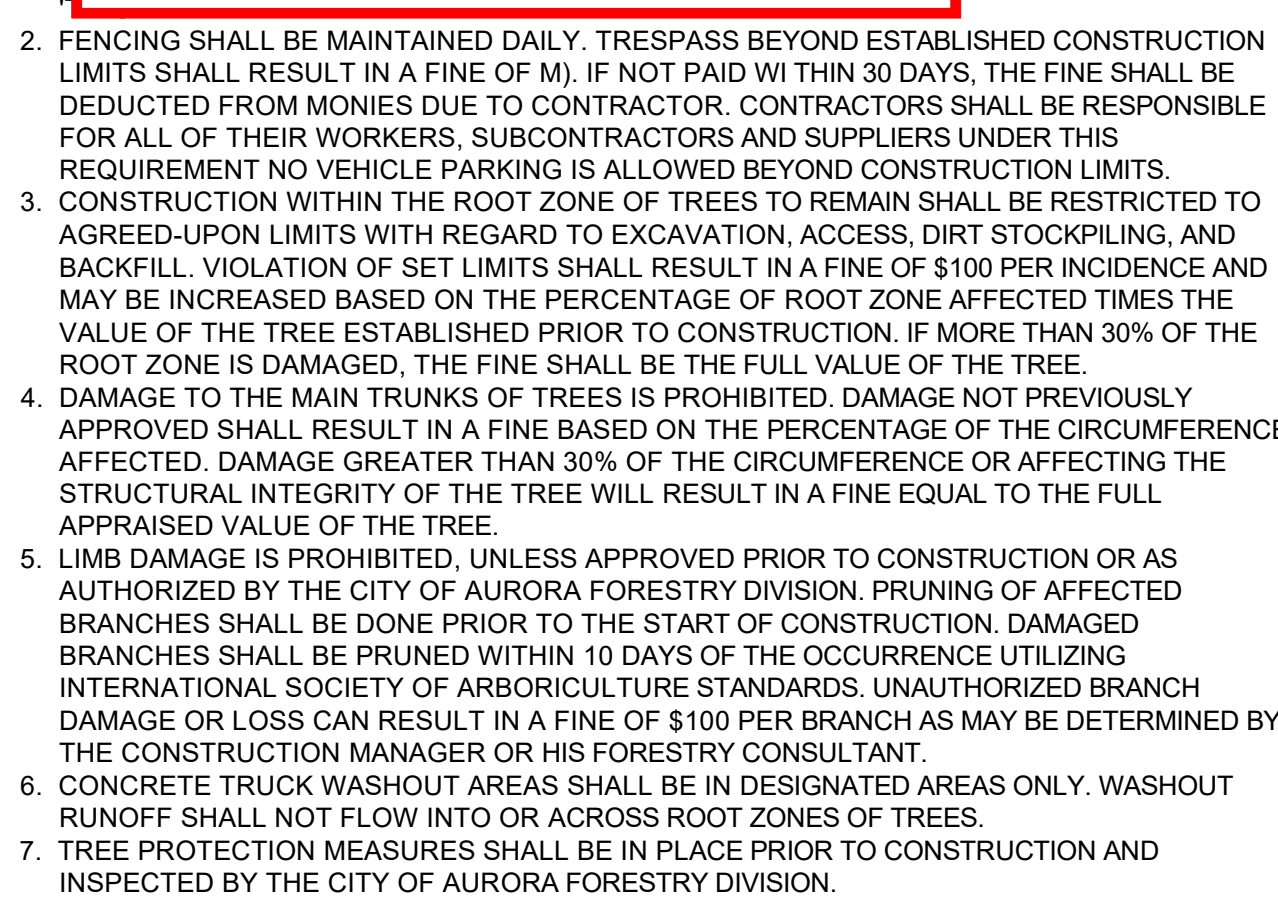


5 OF 8

LANDSCAPE DATA (CITY OF AURORA)


LANDSCAPE AREA TABLE (DISTURBED AREAS ONLY)		
AREA TYPE	ZONE (WATER USAGE)	SQUARE FEET
COOL SEASON GRASS/SOD	MODERATE	659 SF (OUTSIDE LOT: 1,906 SF)
MULCHED PLANTING BEDS	LOW	8,659 SF (OUTSIDE LOT: 1,272 SF)

NON-RESIDENTIAL BUILDING ELEVATION LANDSCAPING INFORMATION			
ELEVATION (DIRECTION FACING)	ELEVATION LENGTH	TREE EQUIVALENT REQUIRED	TREES PROVIDED (1 TREE EQUIVALENT PER 40 LF)
NORTH (N)	411'	11	6 TREES* + 33 SHRUBS + 87 PERN
WEST (W)	80'	2	1 TREES* + 12 SHRUBS
SOUTH (S)	316'	8	9 TREES + 43 SHRUBS + 35 PERN

*REQUIRED TREES WERE CONVERTED TO SHRUB EQUIVALENTS @ 10 SHRUBS PER TREE OR PERENNIAL EQUIVALENTS @ 30 PERENNIALS PER TREE

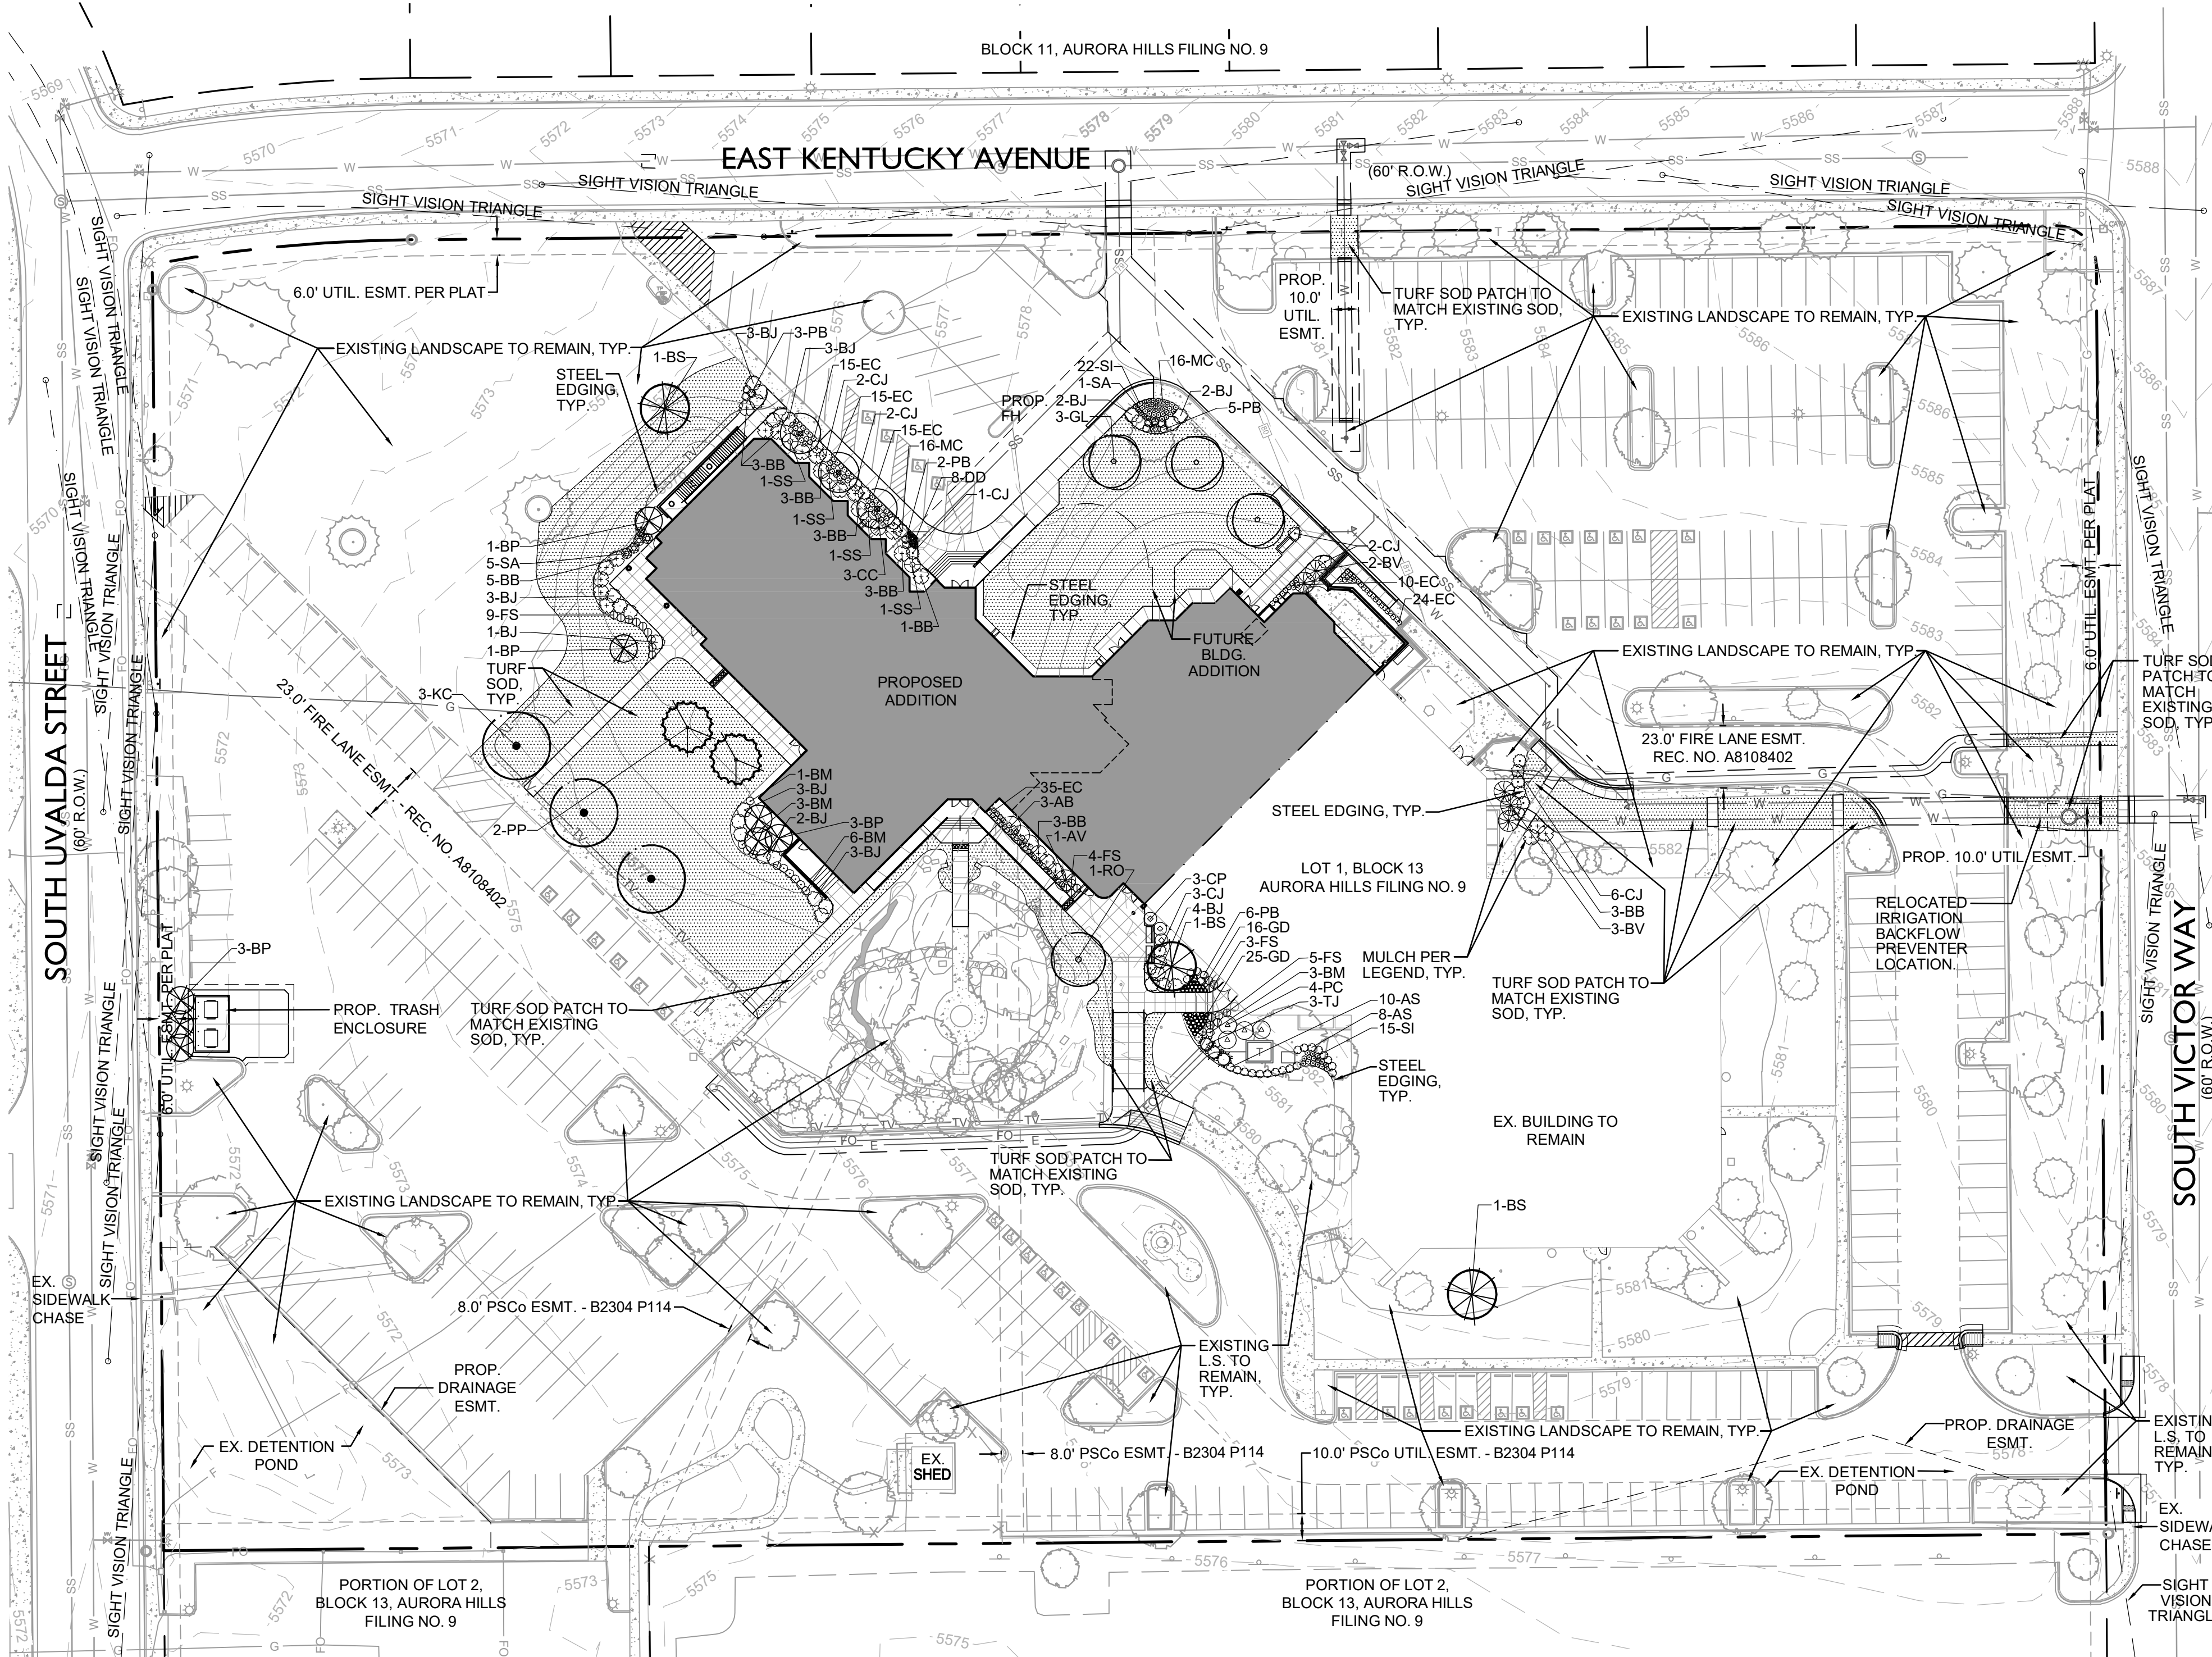

CAUTION: UTILITIES EXIST WITHIN CONSTRUCTION LIMITS. CONTRACTOR IS RESPONSIBLE FOR IDENTIFYING THEIR LOCATION PRIOR TO CONSTRUCTION.

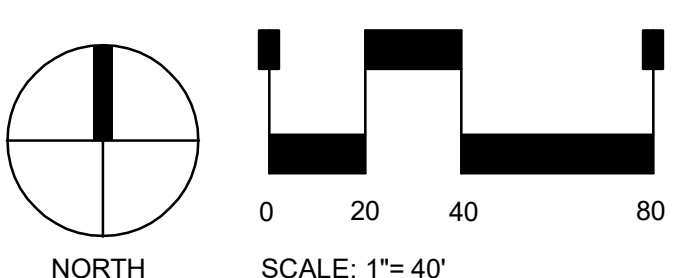

CAUTION - NOTICE TO CONTRACTOR

THE CONTRACTOR IS SPECIFICALLY CAUTIONED THAT THE LOCATION AND/OR ELEVATION OF EXISTING UTILITIES AS SHOWN ON THESE PLANS IS BASED ON RECORDS OF THE VARIOUS UTILITY COMPANIES AND, WHERE POSSIBLE, MEASUREMENTS TAKEN IN THE FIELD. THE INFORMATION IS NOT TO BE RELIED ON AS BEING EXACT OR COMPLETE. THE CONTRACTOR MUST CALL THE LOCAL UTILITY LOCATION CENTER AT LEAST 48 HOURS BEFORE ANY EXCAVATION TO REQUEST EXACT FIELD LOCATIONS OF THE UTILITIES. IT SHALL BE THE RESPONSIBILITY OF THE CONTRACTOR TO RELOCATE ALL EXISTING UTILITIES WHICH CONFLICT WITH THE PROPOSED IMPROVEMENTS SHOWN ON THE PLANS.

THE CONTRACTOR SHALL BE RESPONSIBLE FOR ANY DAMAGE TO EXISTING IMPROVEMENTS AND UTILITIES AND SHALL REPAIR ANY DAMAGE AT HIS EXPENSE.



CITY STANDARD LANDSCAPE NOTES

- REFER TO LANDSCAPE DETAIL SHEET FOR ADDITIONAL LANDSCAPE NOTES.
- ALL PROPOSED LANDSCAPING WITHIN THE SIGHT TRIANGLE SHALL BE IN COMPLIANCE WITH COA ROADWAY SPECIFICATIONS, SECTION 4.04.2.10'.
- THE FINAL LANDSCAPE PLAN SHALL COMPLY WITH THE APPROVED PRELIMINARY LANDSCAPE PLAN.
- THE LANDSCAPE PLAN WILL BE UTILIZED FOR CODE ENFORCEMENT AND LANDSCAPE INSPECTION PURPOSES.
- SOD AND SHRUB BED AREAS SHALL RECEIVE SIX INCHES OF APPROVED TOPSOIL.
- ALL UTILITY EASEMENTS SHALL REMAIN UNOBSTRUCTED AND FULLY ACCESSIBLE ALONG THEIR ENTIRE LENGTH FOR MAINTENANCE EQUIPMENT ENTRY.
- THE DEVELOPER, HIS SUCCESSORS AND ASSIGNS, SHALL BE RESPONSIBLE FOR INSTALLATION, MAINTENANCE AND REPLACEMENT OF ALL LANDSCAPING MATERIALS SHOWN OR INDICATED ON THE APPROVED SITE PLAN OR LANDSCAPE PLAN ON FILE IN THE PLANNING DEPARTMENT. ALL LANDSCAPING WILL BE INSTALLED AS DELINEATED ON THE PLAN, PRIOR TO ISSUANCE OF CERTIFICATE OF OCCUPANCY.
- ALL LANDSCAPED AREAS AND PLANT MATERIAL, EXCEPT FOR NON-IRRIGATED NATIVE, RESTORATIVE, AND DRYLAND GRASS AREAS THAT COMPLY WITH REQUIREMENTS FOUND IN SEC. 146-1429, MUST BE WATERED BY AN AUTOMATIC UNDERGROUND IRRIGATION SYSTEM. IRRIGATION SYSTEM DESIGN, INSTALLATION, OPERATION, AND MAINTENANCE SHALL CONFORM TO REQUIREMENTS FOUND IN THE CITY OF AURORA IRRIGATION ORDINANCE.
- LANDSCAPE MATERIAL PLACEMENT SHALL NOT BE PLACED OR KEPT NEAR FIRE HYDRANTS, FIRE DEPARTMENT INLET CONNECTIONS OR FIRE PROTECTION CONTROL VALVES IN A MANNER THAT WOULD PREVENT SUCH EQUIPMENT OR FIRE HYDRANTS FROM BEING IMMEDIATELY DISCERNIBLE. THE FIRE DEPARTMENT SHALL NOT BE DETERRED OR HINDERED FROM GAINING IMMEDIATE ACCESS TO FIRE PROTECTION EQUIPMENT OR HYDRANTS.
- ALL FIRE HYDRANTS WILL BE LOCATED NOT LESS THAN THREE FEET SIX INCHES (3'-6") AND NOT MORE THAN EIGHT FEET (8') FROM THE BACK OF CURB TO THE CENTER OF THE HYDRANT, UNOBSTRUCTED ON THE STREET SIDE WITH A MINIMUM CLEARANCE ON ALL OTHER SIDES OF FIVE FEET (5').
- LANDSCAPING MATERIAL SHOWN WITHIN THE SITE PLAN CANNOT ENROACH INTO ROADWAYS THAT ARE DEDICATED (OR DESIGNATED) AS FIRE LANE EASEMENTS (OR CORRIDORS).

QUEEN OF PEACE CATHOLIC PARISH

LOT 1, BLOCK 13, AURORA HILLS, FILING NO. 9,
CITY OF AURORA, ARAPAHOE COUNTY, STATE OF COLORADO.
RECEPTION NO. 933522 RECORDED ON OCTOBER 16 1964.

MAJOR SITE PLAN AMENDMENT

PLANT LIST

SYMBOL	QTY	ABBR	COMMON/BOTANICAL NAME	SIZE	HT. X SPD.	HYDRO ZONE	REMARKS
OVERSTORY TREES							
	1	RO	NORTHERN RED OAK <i>Quercus rubra</i>	3.0" CAL. B&B	50' X 30'	LOW	FULL CROWN, STAKED, SPECIMEN QUALITY
	3	GL	GREENSPIRE LINDEN <i>Tilia cordata 'greenspire'</i>	3.0" CAL. B&B	40' X 30'	LOW	FULL CROWN, STAKED, SPECIMEN QUALITY
	3	KC	"ESPRESSO" KENTUCKY COFFEETREE <i>Gymnocladus dioica 'Espresso'</i>	3.0" CAL. B&B	50' X 35'	LOW	FULL CROWN, STAKED, SPECIMEN QUALITY
ORNAMENTAL TREES							
	3	AB	AUTUMN BRILLIANCE SERVICEBERRY <i>Amerlanier x grandiflora 'Autumn Brilliance'</i>	3.0" CAL. B&B	18' X 10'	LOW / MEDIUM	FULL CROWN, STAKED, SPECIMEN QUALITY
	3	CC	CANADA RED CHOKECHERRY <i>Prunus virginiana 'shubert'</i>	3.0" CAL. B&B	25' X 20'	LOW / MEDIUM	FULL CROWN, STAKED, SPECIMEN QUALITY
EVERGREEN TREES							
	3	BS	COLORADO BLUE SPRUCE <i>Picea pungens</i> var. <i>glauca</i>	10' HT. B&B	60' X 30'	LOW / MEDIUM	FULL CROWN, STAKED, SPECIMEN QUALITY
	8	BP	BAKERI SPRUCE <i>Picea pungens 'Bakeri'</i>	10' HT. B&B	30' X 10'	LOW	FULL CROWN, STAKED, SPECIMEN QUALITY
	2	PP	PONDEROSA PINE <i>Pinus ponderosa</i>	10' HT. B&B	50' X 30'	LOW	FULL CROWN, STAKED, SPECIMEN QUALITY
DECIDUOUS SHRUBS							
	4	SS	RED TWIG DOGWOOD <i>Cornus sericea</i>	#5 (18"-24" HT.)	6' X 6'	MEDIUM	SPACING PER PLAN FULL FORM
	16	PB	CRIMSON PYGMY BARBERRY <i>Berberis thunbergii 'Atropurpurea Nana'</i>	#5 (12"-15" HT.)	2' X 3'	LOW / MEDIUM	SPACING PER PLAN FULL FORM
	13	BM	BLUE MIST SPIREA <i>Caryopteris x clandonensis</i>	#5 (18"-24" HT.)	3' X 3'	LOW	SPACING PER PLAN FULL FORM
	21	FS	GOLD FLAME SPIREA <i>Spiraea japonica 'Goldflame'</i>	#5 (12"-15" HT.)	3' X 3'	LOW / MEDIUM	SPACING PER PLAN FULL FORM
	19	BB	DWARF BURNING BUSH <i>Euonymus alatus 'Compactus'</i>	#5 (18"-24" HT.)	6' X 6'	LOW / MEDIUM	SPACING PER PLAN FULL FORM
	23	AS	ANTHONY WATERER SPIREA <i>Spiraea bumalda 'Anthony waterer'</i>	#5 (15"-18" HT.)	3' X 3'	LOW / MEDIUM	SPACING PER PLAN FULL FORM
	3	CP	CISTENA PLUM <i>Prunus cistena</i>	#5 (18"-24" HT.)	6' X 5'	LOW	SPACING PER PLAN FULL FORM
	4	PC	PEKING COTONEASTER <i>Cotoneaster acutifolia</i>	#5 (18"-24" HT.)	6' X 7'	LOW	SPACING PER PLAN FULL FORM
	6	SA	SNOWMOUND SPIREA <i>Spiraea nipponica 'Snowmound'</i>	#5 (18"-24" HT.)	4' X 4'	LOW	SPACING PER PLAN FULL FORM
	1	AV	ARROWWOOD VIBURNUM <i>Viburnum dentatum</i>	#5 (18"-24" HT.)	10' X 8'	MED	SPACING PER PLAN FULL FORM
	5	BV	BURKWOOD VIBURNUM <i>Viburnum x burkwoodii</i>	#5 (18"-24" HT.)	6' X 8'	MED	SPACING PER PLAN FULL FORM
EVERGREEN SHRUBS							
	18	CJ	BLUE CHIP JUNIPER <i>Juniperus horizontalis 'Blue Chip'</i>	#5 (8"-12" SPD.)	1' X 5'	LOW	SPACING PER PLAN FULL FORM
	3	TJ	TAMMII JUNIPER <i>Juniperus sabina 'Tamariscifolia'</i>	#5 (24" MIN. SPD.)	3' X 6'	LOW	SPACING PER PLAN FULL FORM
	26	BJ	BUFFALO JUNIPER <i>Juniperus sabina 'Buffalo'</i>	#5 (8"-12" SPD.)	1' X 5'	LOW	SPACING PER PLAN FULL FORM
PERENNIALS / GROUND COVER							
	37	SI	SIBERIAN IRIS <i>Iris sibirica 'Ruffled velvet'</i>	#1	3' X 2'	LOW	SPACING PER PLAN FULL FORM
	114	EC	EUONYMUS COLORATUS <i>Euonymus fortunei 'Coloratus'</i>	#1	1' X 2'	MED	SPACING PER PLAN FULL FORM
	41	GD	BASKET OF GOLD <i>Alyssum saxatile</i>	#1	0.75' X 1'	LOW	SPACING PER PLAN FULL FORM
	16	MC	MOONBEAM COREOPSIS <i>Coreopsis verticillata 'Moonbeam'</i>	#1	1.5' X 1.5'	LOW	SPACING PER PLAN FULL FORM
	8	DD	STELLA D'ORO DAYLILY <i>Hemerocallis 'Stella De Oro'</i>	#1	2' X 1.5'	LOW	SPACING PER PLAN FULL FORM

Turf Sod / Native Seed			
20,739 SF	TALL FESCUE & BLUEGRASS (90/10 MIX) SOD	GRASS SOD	SEE L.S. NOTES (TO MATCH EXISTING)

MULCH		COLOR/MATERIAL:	ROCK MULCH / WOOD MULCH
		AREA:	5,918 SF
		TYPE:	ALL SHRUB BEDS ARE TO BE MULCHED WITH 4" DEPTH, 1-1/2" 3" RIVER ROCK COBBLE MULCH WITH DOUBLE SHREDDED BARK MULCH RINGS (4" THICK). ALL GROUND COVER BEDS ARE TO BE MULCHED WITH 4" DEPTH SHREDDED CEDAR MULCH. SEE LANDSCAPE NOTES.
			ROLLED TOP STEEL EDGING - 342 LF

TREE MITIGATION TABLE

QTY	COMMON/BOTANICAL NAME	MINIMUM SIZE PER CODE	PROPOSED SIZE	MITIGATION INCHES EACH	TOTAL MITIGATION INCHES
1	NORTHERN RED OAK <i>Quercus rubra</i>	2.5"	3.0"	0.5"	0.5"
3	GREENSPIRE LINDEN <i>Tilia cordata 'greenspire'</i>	2.5"	3.0"	0.5"	1.5"
3	"ESPRESSO" KENTUCKY COFFEETREE <i>Gymnocladus dioica 'Espresso'</i>	ABOVE REQUIRED	3.0"	3.0"	9.0"
3	AUTUMN BRILLIANCE SERVICEBERRY <i>Amerlanier x grandiflora 'Autumn Brilliance'</i>	2.0"	3.0"	1.0"	3.0"
3	CANADA RED CHOKECHERRY <i>Prunus virginiana 'shubert'</i>	2.0"	3.0"	1.0"	3.0"
2	COLORADO BLUE SPRUCE <i>Picea pungens</i> var. <i>glauca</i>	6"	10"	2.0"	4.0"
1	COLORADO BLUE SPRUCE <i>Picea pungens</i> var. <i>glauca</i>	ABOVE REQUIRED	10"	3.0	3.0"
8	BAKERI SPRUCE <i>Picea pungens 'Bakeri'</i>	6"	8"	1.0"	8.0"
2	PONDEROSA PINE <i>Pinus ponderosa</i>	6"	10"	2.0"	4.0"
				Total:	36"

NOTE: THE TOTAL 'TO BE REMOVED' DIAMETER INCHES REQUIRING MITIGATION EQUALS 36 INCHES. REFER TO THE LANDSCAPE PLAN FOR LOCATION OF TREES PROPOSED FOR REPLACEMENT OF CALIPER INCHES LOST. PER THE TREE MITIGATION TABLE ABOVE, ALL PROPOSED TREES HAVE BEEN INCREASED IN SIZE OVER THE MINIMUMS REQUIRED BY CODE TO SATISFY MITIGATION INCHES. A TOTAL OF 0 CALIPER INCHES REMAINS FOR MITIGATION. AMOUNT OF CASH PAYMENT TO THE TREE PLANTING FUND IS TO BE DETERMINED BY THE CITY OF AURORA FORESTRY DIVISION.

CALIPER INCHES REMOVED	CALIPER INCHES RELOCATED	CALIPER INCHES REPLACED FOR MITIGATION AND/OR AMOUNT PAID TO "TREE PLANTING FUND"
36"	36"	0"

Sterling Design Associates, LLC
CIVIL ENGINEERS - LANDSCAPE ARCHITECTS

2009 W. Littleton Blvd. #300
Littleton, CO 80120
303.794.4727 ph
www.SterlingDesignAssociates.com

PREPARED UNDER THE DIRECT SUPERVISION OF
JOSEPH L. WILSON, PLA, CID
COLORADO REGISTRATION LA-304 FOR & ON BEHALF OF
STERLING DESIGN ASSOCIATES, LLC

PRELIMINARY
NOT FOR CONSTRUCTION

STERLING DESIGN ASSOCIATES, LLC

ISSUES & REVISIONS			
NO. 1	DATE: 05/02/2019	BY: JLW	
DESCRIPTION: FIRST MSPA RE-SUBMITTAL			
NO. 2	DATE: 06/14/2019	BY: JLW	
DESCRIPTION: SECOND MSPA TECHNICAL SUBMITTAL			
NO. 3	DATE: -	BY: -	
DESCRIPTION: -			
NO. 4	DATE: -	BY: -	
DESCRIPTION: -			
NO. 5	DATE: -	BY: -	
DESCRIPTION: -			
NO. 6	DATE: -	BY: -	
DESCRIPTION: -			

DATE:	SCALE:
FEBRUARY 2019	1"=30'
PROJECT MANAGER:	PROJECT NO.:
JLW	-
DRAWN BY:	DRAWING FILE:
JLW	-

PROJECT:
QUEEN OF PEACE CATHOLIC PARISH
13120 EAST KENTUCKY AVENUE
AURORA, CO 80012


CLIENT:
ARCHDIOCESE OF DENVER
1300 S STEELE STREET
DENVER, CO 80210

TEL: (303) 722-4687

SHEET TITLE:
PRELIMINARY LANDSCAPE PLAN

SHEET NUMBER:
6 OF 8


QUEEN OF PEACE CATHOLIC PARISH
LOT 1, BLOCK 13, AURORA HILLS, FILING NO. 9,
CITY OF AURORA, ARAPAHOE COUNTY, STATE OF COLORADO.
RECEPTION NO. 933522 RECORDED ON OCTOBER 16 1964.
MAJOR SITE PLAN AMENDMENT

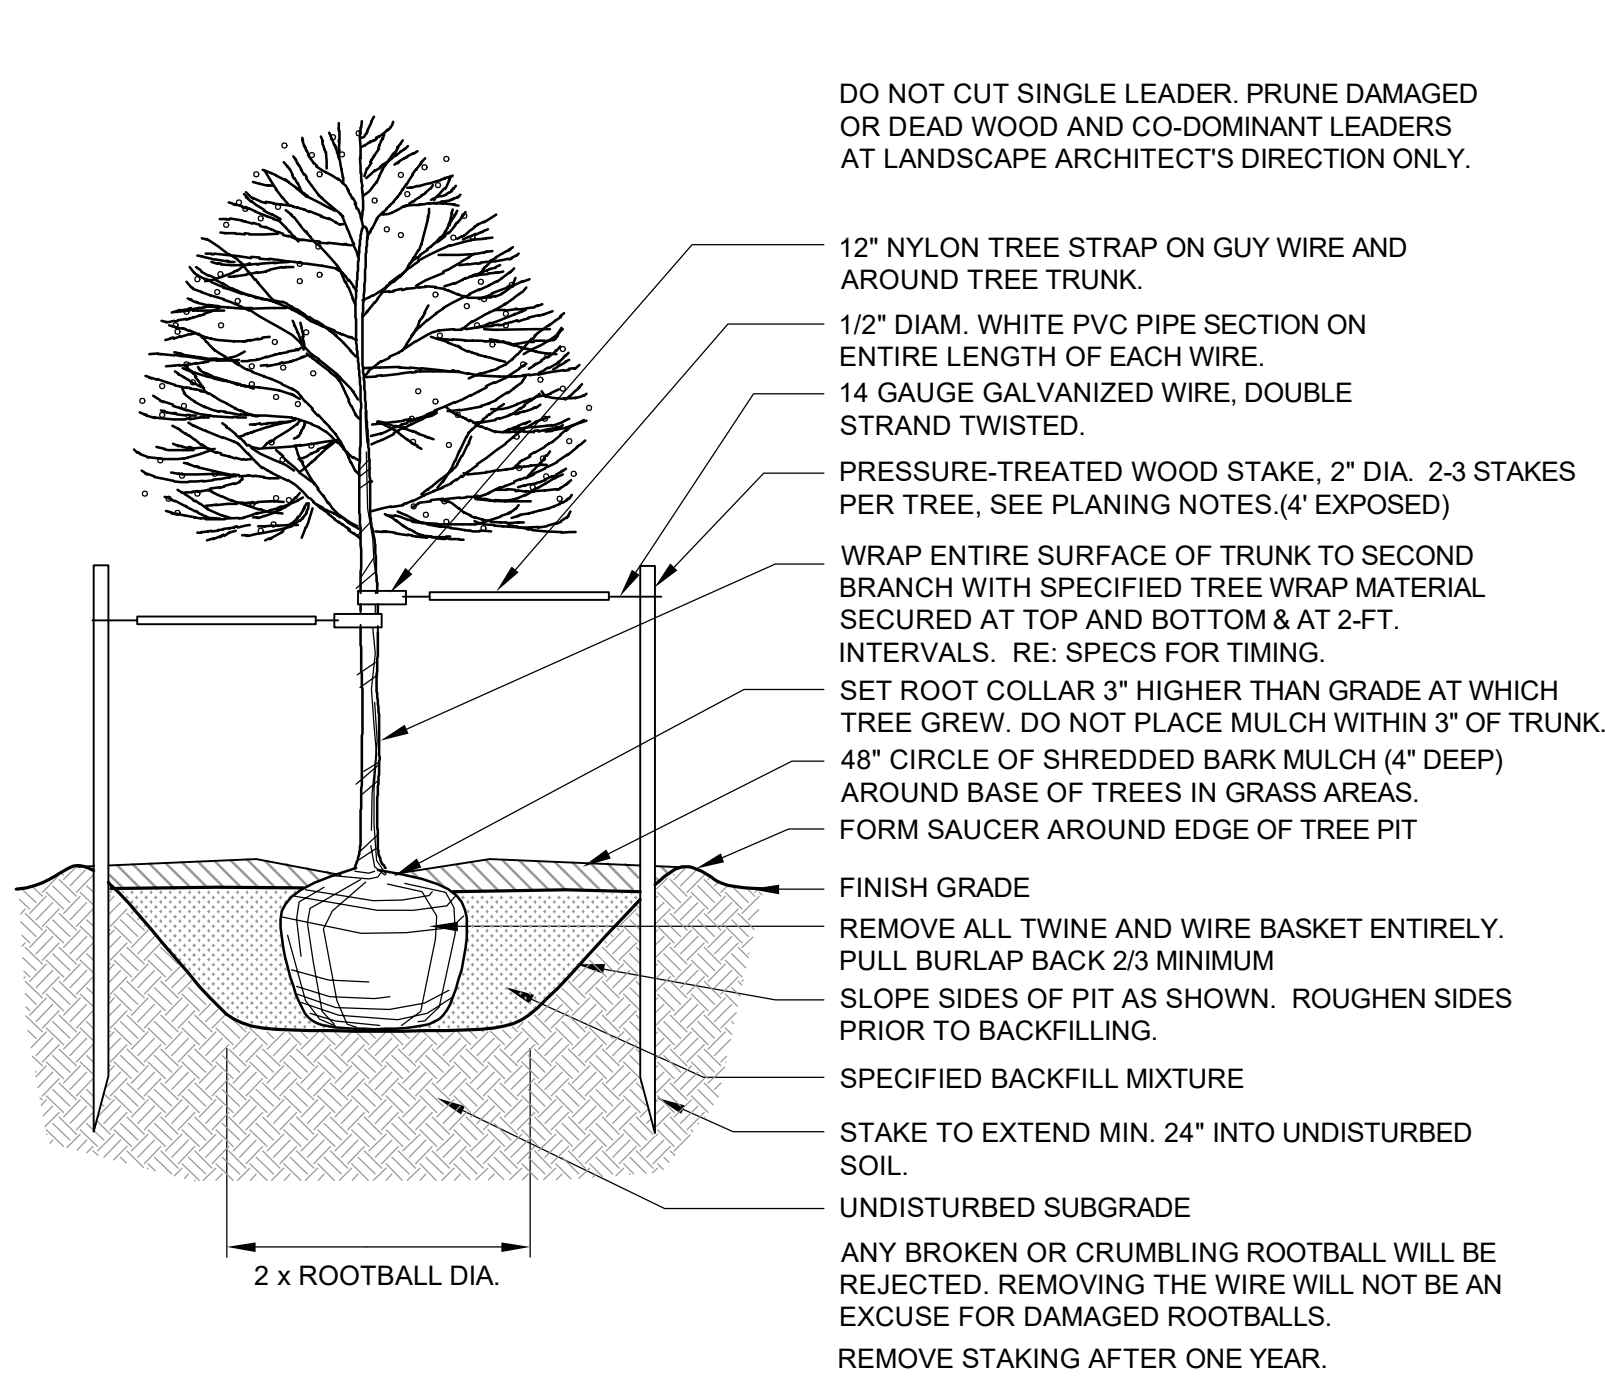

SHADE TREE PLANTING

NOT TO SCALE


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EVERGREEN TREE PLANTING

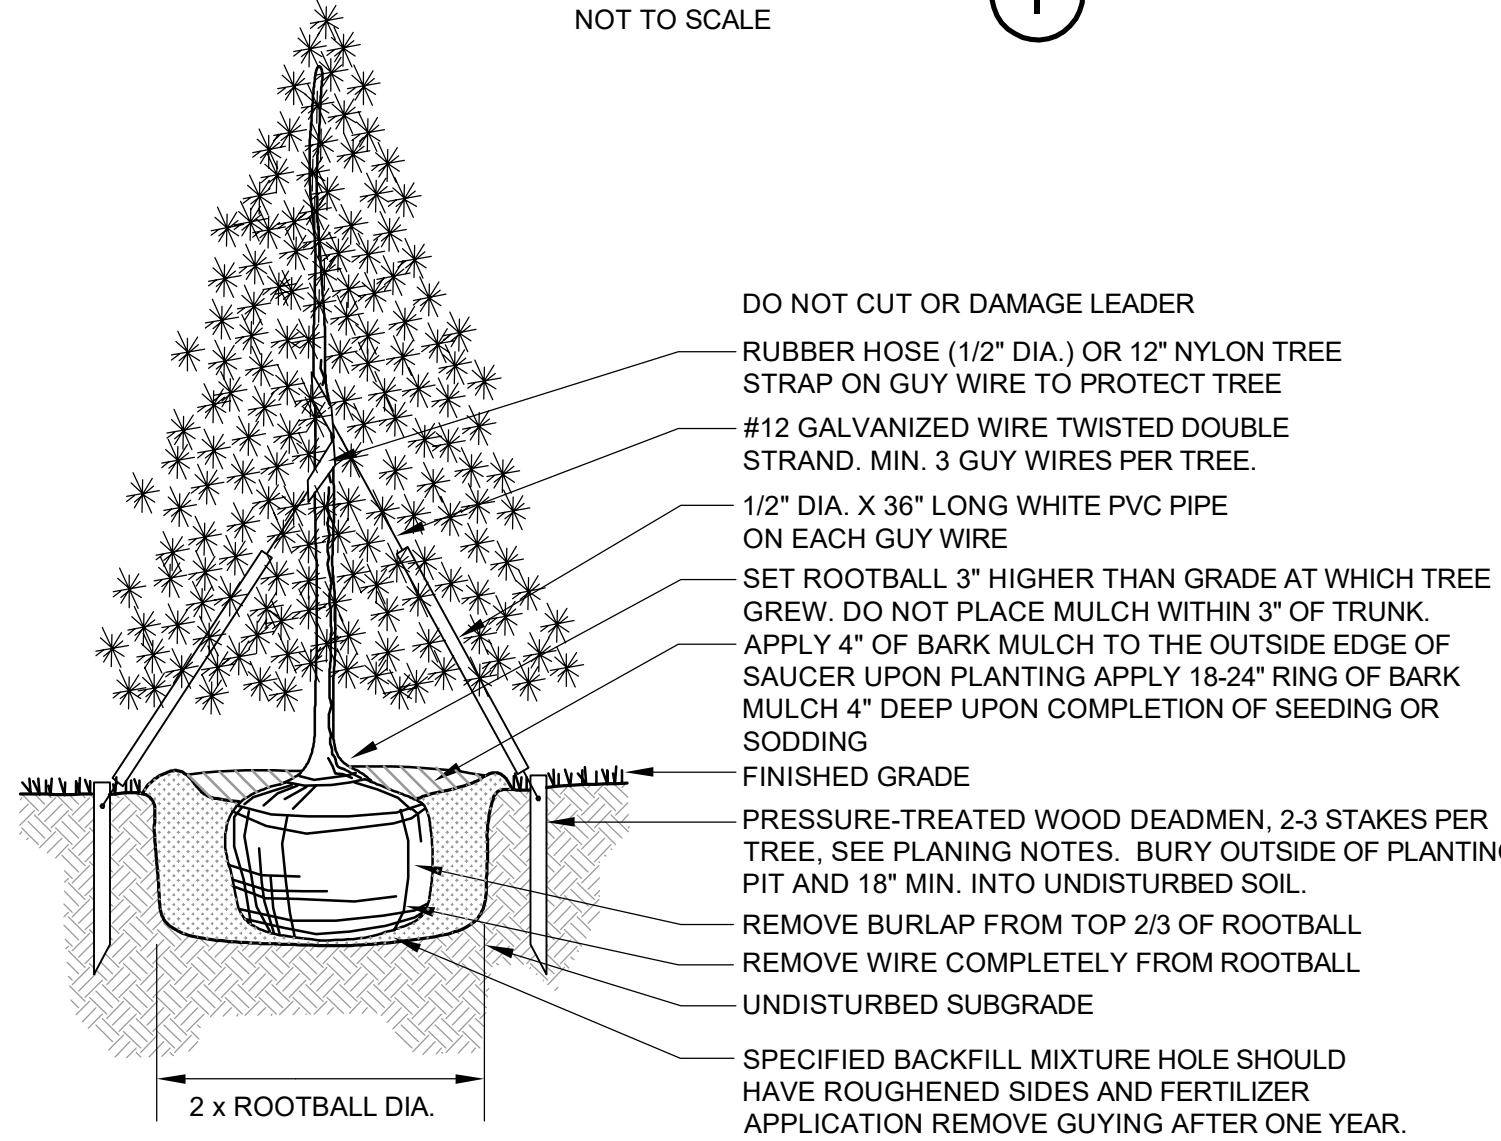NOT TO SCALE


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TYPICAL PLANTING BED, CRUSHER FINES, & EDGING DETAIL

NOT TO SCALE


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CLUMP TREE PLANTING

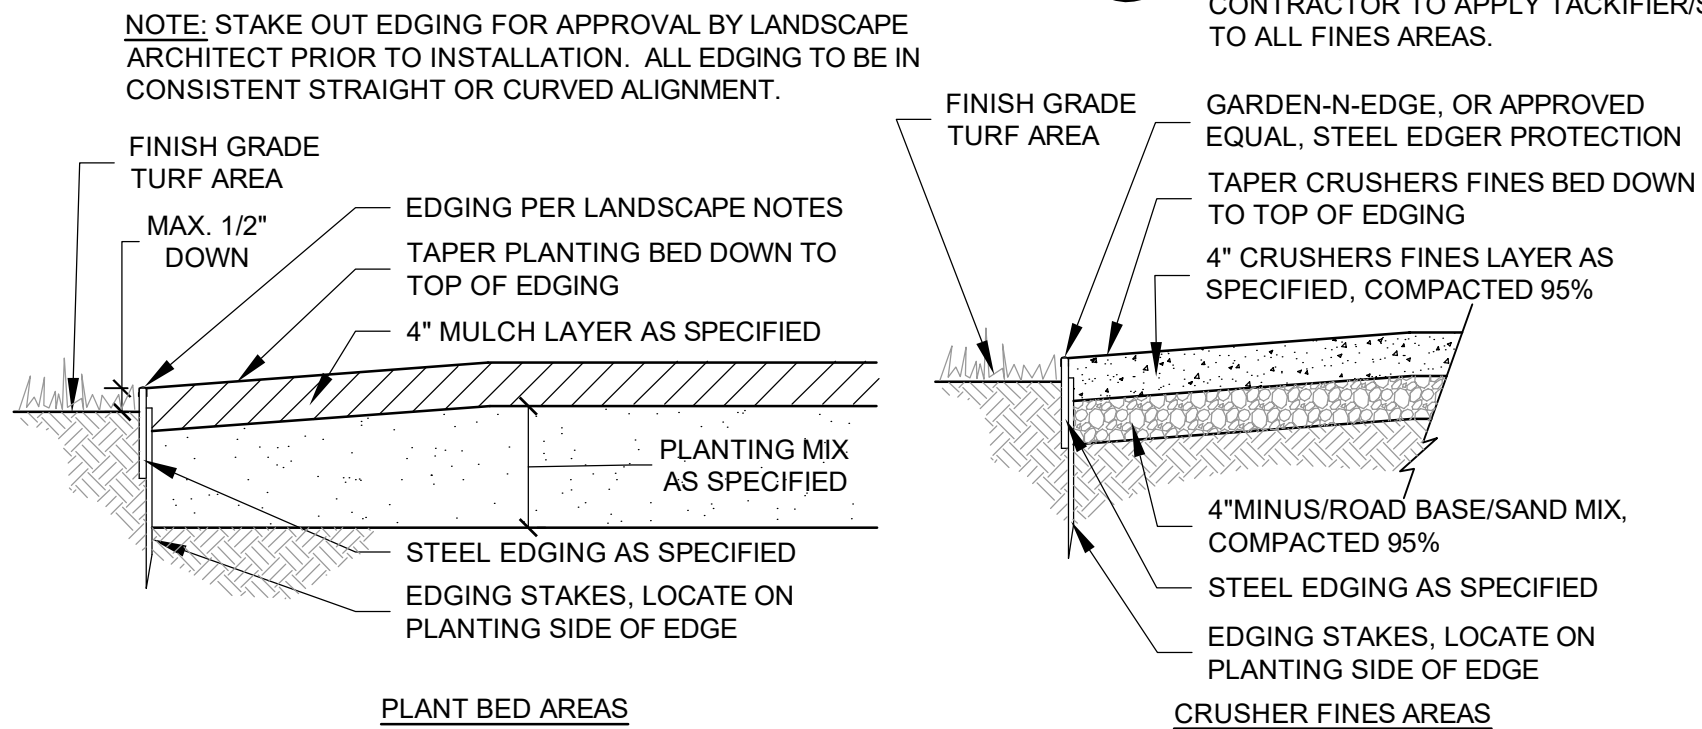NOT TO SCALE

2

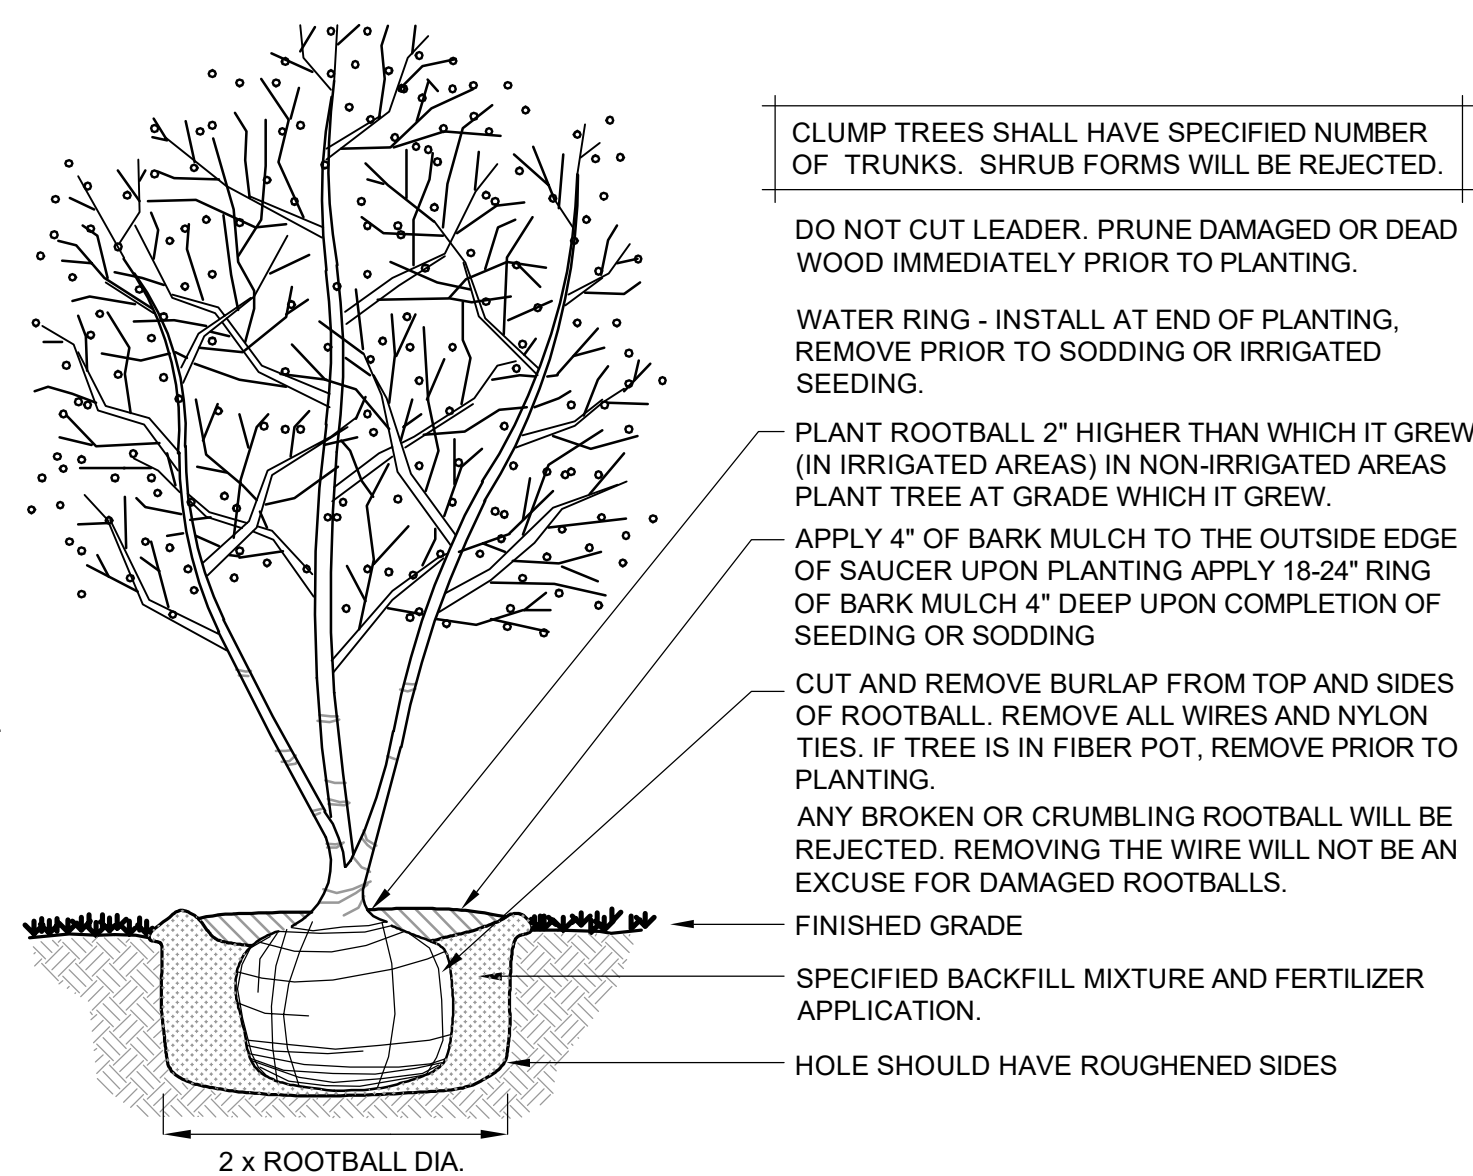

SHRUB/PERENNIAL PLANTING

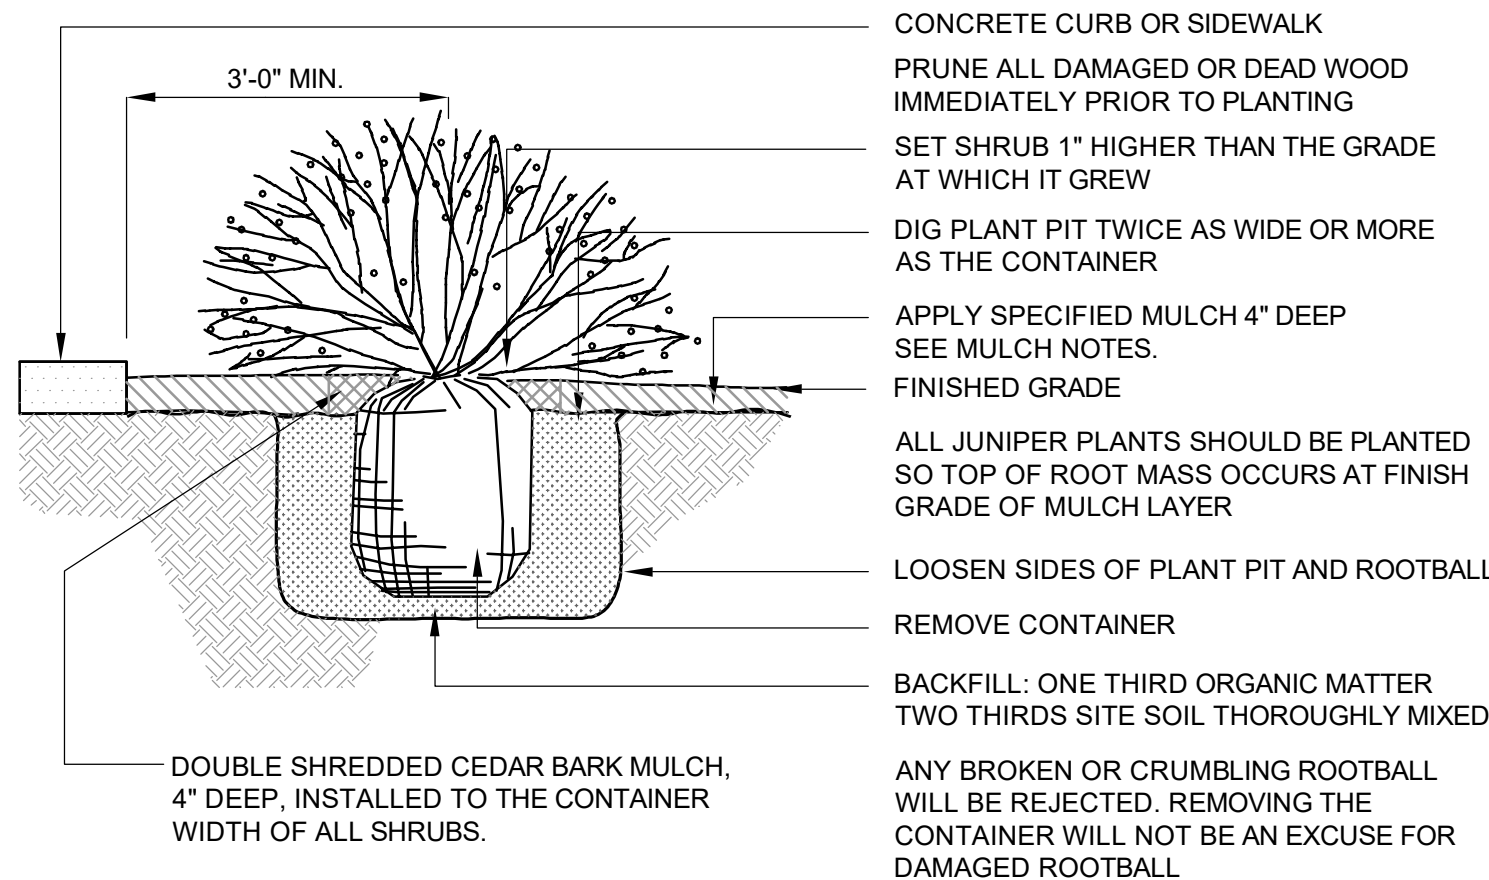NOT TO SCALE

4

HOOP RACK - Specifications and Space Use

Product Name
Dero Hoop Rack
As manufactured by Dero Bike Racks

Bikes Parked per Unit: 2

Materials:
1.5" schedule 40 pipe (1.9" OD)

Finishes

An after fabrication hot dipped galvanized finish is standard. 250 TGIC powder coat colors and a stainless steel option are also available.

Our powder coat finish assures a high level of adhesion and durability by following these steps:
1. Sandblast
2. Iron phosphate pretreatment
3. Epoxy primer electrostatically applied
4. Final thick TGIC polyester powder coat

NOTES:

1. INSTALL RACK PARALLEL TO WALKWAY AS SHOWN - SPACED 30" FROM EDGE.
2. INSTALL WITH IG (IN-GROUND) MOUNT PER MANUFACTURER'S RECOMMENDATIONS.
3. BLACK COLOR, POWDERCOAT

BIKE RACK DETAIL


NOT TO SCALE

6

STANDARD LANDSCAPE NOTES

(THE "THE CITY OF AURORA LANDSCAPE ORDINANCE / REFERENCE MANUAL" SHALL TAKE PRECEDENCE OVER THE "STANDARD LANDSCAPE NOTES" BELOW)

1. ALL UTILITY EASEMENTS SHALL REMAIN UNOBSTRUCTED AND FULLY ACCESSIBLE ALONG THEIR ENTIRE LENGTH FOR MAINTENANCE EQUIPMENT ENTRY.
2. THE DEVELOPER, HIS SUCCESSORS AND ASSIGNS, SHALL BE RESPONSIBLE FOR THE INSTALLATION, MAINTENANCE AND REPLACEMENT OF ALL LANDSCAPING MATERIALS SHOWN OR INDICATED ON THE APPROVED SITE PLAN OR LANDSCAPE PLAN ON FILE IN THE PLANNING DEPARTMENT. ALL LANDSCAPING WILL BE INSTALLED AS DELINEATED ON THE PLAN, PRIOR TO THE ISSUANCE OF CERTIFICATES OF OCCUPANCY.
3. ALL LANDSCAPED AREAS AND PLANT MATERIAL, EXCEPT FOR NON-IRRIGATED NATIVE, RESTORATIVE, AND DRYLAND GRASS AREAS THAT COMPLY WITH REQUIREMENTS FOUND IN SEC. 146-1429 AND/OR SEC. 146-1435 MUST BE WATERED BY AN AUTOMATIC UNDERGROUND IRRIGATION SYSTEM. IRRIGATION SYSTEM DESIGN, INSTALLATION, OPERATION, AND MAINTENANCE SHALL CONFORM TO REQUIREMENTS FOUND IN THE CITY OF AURORA IRRIGATION ORDINANCE. ALL SHRUB BEDS SHALL BE IRRIGATED BY DRIP IRRIGATION.
4. COORDINATION:
THIS LANDSCAPE ARCHITECTURAL SITE PLAN IS TO BE USED IN CONJUNCTION WITH THE CIVIL, ARCHITECTURAL, MECHANICAL, ELECTRICAL, STRUCTURAL AND IRRIGATION PLANS AND SPECIFICATIONS TO FORM COMPLETE INFORMATION REGARDING THIS SITE.
5. SOIL PREPARATION:
AT A MINIMUM, ALL TOPSOIL SHALL BE AMENDED WITH FOUR CUBIC YARDS OF ORGANIC MATERIAL PER 1,000 SF OF AREA IS THE MINIMUM AMOUNT CURRENTLY REQUIRED TO OBTAIN A LAWN PERMIT. AMENDMENT SHALL BE MECHANICALLY INTEGRATED INTO THE TOP 6" OF SOIL BY MEANS OF ROTOTILLING AFTER CROSS-RIPPING. NO MANURE OR ANIMAL-BASED PRODUCTS SHALL BE USED FOR ORGANIC AMENDMENTS. AFTER FINISH GRADES HAVE BEEN ESTABLISHED, IT IS RECOMMENDED TO HAVE SOIL SAMPLES TESTED BY AN ESTABLISHED SOIL TESTING LABORATORY FOR THE FOLLOWING: GENERAL SOIL FERTILITY, PH, ORGANIC MATTER CONTENT, SALT (CEC), LIME, SODIUM ADSORPTION RATIO (SAR) AND BORON CONTENT. SUBMIT THE PROJECT'S PLANT LIST TO THE LABORATORY ALONG WITH THE SOIL SAMPLES. THE SOIL REPORT PRODUCED BY THE LABORATORY SHALL CONTAIN RECOMMENDATIONS FOR THE FOLLOWING (AS APPROPRIATE): GENERAL SOIL PREPARATION AND BACKFILL MIXES, PRE-PLANT FERTILIZER APPLICATIONS, AND ANY OTHER SOIL RELATED ISSUES. THE REPORT SHALL ALSO PROVIDE A FERTILIZER PROGRAM FOR THE ESTABLISHMENT PERIOD AND FOR LONG-TERM MAINTENANCE.
2. PLANTING:
TREES AND SHRUBS SHALL BE PLANTED PER DETAILS. STAKE AND GUY TREES PER DETAILS. TREE AND SHRUB BED LOCATIONS SHALL BE APPROVED PRIOR TO PLANTING. BACKFILL WITH 1/3 SOIL AMENDMENT AND 2/3 SITE SOIL, THOROUGHLY MIXED. FERTILIZE AS RECOMMENDED WITH AGRIFORM TABLETS.
3. MULCH:
AFTER ALL PLANTING IS COMPLETE, INSTALL A MINIMUM 4" THICK LAYER OF MULCH AS SPECIFIED IN THE LEGEND. INSTALL A 4" THICK RING OF DOUBLE SHREDDED CEDAR BARK MULCH AROUND ALL PLANT MATERIAL IN ROCK MULCH BEDS WHERE LANDSCAPING IS SHOWN ON THE PLANS. WOOD MULCH RING SIZE SHALL BE THE SIZE OF THE OF SHRUB, PERENNIAL, AND ORNAMENTAL GRASS'S CONTAINER/ROOTBALL. TREE INSTALLATION/RING SHALL REFERENCE INDUSTRY STANDARDS SET FORTH IN THE CONTRACTORS HANDBOOK PUBLISHED BY THE STATE'S LANDSCAPE CONTRACTORS ASSOCIATION. ALL MULCH SHALL BE HARVESTED IN A SUSTAINABLE MANNER FROM A LOCAL SOURCE. INSTALL WEED BARRIER FABRIC UNDER ALL ROCK MULCH SHRUB BEDS SPECIFIED ON THE PLANS ONLY. NO LANDSCAPE FABRIC SHALL BE USED IN WOOD MULCH AREAS. NO PLASTIC WEED BARRIERS SHALL BE SPECIFIED (SUBMIT SAMPLES). ABSOLUTELY NO EXPOSED GROUND SHALL BE LEFT SHOWING ANYWHERE ON THE PROJECT AFTER MULCH HAS BEEN INSTALLED.
4. LIGHTING:
FREESTANDING LIGHTS AS SHOWN ON THIS PLAN WILL BE EXISTING TO REMAIN.
5. THE LANDSCAPE PLAN MUST REFLECT THE LOCATION OF ALL FIRE HYDRANTS, KNOX HARDWARE AND FIRE DEPARTMENT CONNECTIONS TO ENSURE THAT THESE DEVICES ARE NOT PHYSICALLY OR VISUALLY OBSTRUCTED FROM RESPONDING FIRE CREWS. THE SEPARATION REQUIREMENTS FROM FIRE DEPARTMENT CONNECTIONS AND FIRE HYDRANTS MUST MEET BOTH LIFE SAFETY (TYPICALLY 5 FEET AND NO MATERIAL GREATER THAN 2 FEET IN HEIGHT) AND LANDSCAPING REQUIREMENTS. LANDSCAPING MATERIAL CANNOT BE OMITTED OR REDUCED BASED ON THE INSTALLATION OF A FIRE HYDRANT WITHIN A PARKING LOT ISLAND OR PLANT BED. IT IS RECOMMENDED THAT THE ISLAND OR PLANT BED BE CONSTRUCTED LARGE ENOUGH TO ADEQUATELY ACCOMMODATE BOTH LANDSCAPING MATERIAL AND FIRE HYDRANTS IN ORDER TO COMPLY WITH ALL CITY STANDARDS.
6. ALL PROPOSED LANDSCAPING WITHIN THE SIGHT TRIANGLES SHALL BE IN COMPLIANCE WITH COA ROADWAY SPECIFICATIONS SECTION 4.04.2.10. WITHIN ANY SIGHT TRIANGLE AREA NO VEGETATION SHALL BE PLACED THAT WILL OBSTRUCT OR OBSCURE SIGHT VISIBILITY BETWEEN A HEIGHT OF 42 INCHES AND 96 INCHES ABOVE THE ROADWAY SURFACE. TREE BRANCHES WITHIN THE SIGHT TRIANGLE AREA ARE TO BE TRIMMED TO MAINTAIN A CLEAR VISION FOR A VERTICAL HEIGHT OF 96 INCHES ABOVE THE ROADWAY SURFACE.
7. THE WALKS AND PLAZAS SHALL BE CONCRETE UNLESS OTHERWISE NOTED ON THE SITE PLAN. ALL PARKING AND VEHICULAR DRIVE AREAS ARE TO BE PAVED WITH ASPHALT, UNLESS OTHERWISE NOTED ON THE SITE PLAN.

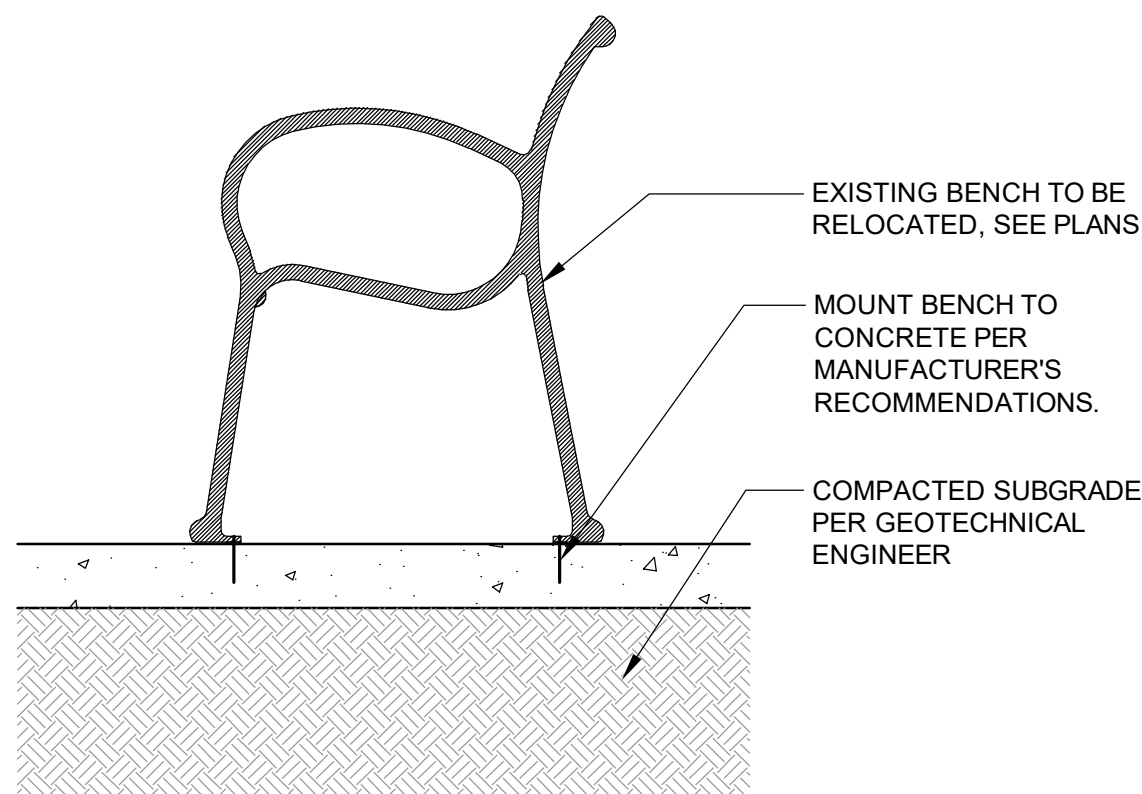

EXISTING BIKE RACK INSTALLATION

NOT TO SCALE

7

Sterling Design Associates, LLC
CIVIL ENGINEERS - LANDSCAPE ARCHITECTS

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303.794.4727 ph
www.SterlingDesignAssociates.com

PREPARED UNDER THE DIRECT SUPERVISION OF
JOSEPH L. WILSON, PLA, CID
COLORADO REGISTRATION LA-304 FOR & ON BEHALF OF
STERLING DESIGN ASSOCIATES, LLC

PRELIMINARY
NOT FOR CONSTRUCTION

STERLING DESIGN ASSOCIATES, LLC			
ISSUES & REVISIONS			
NO. : 1	DATE: 05/02/2019	BY: JLW	
DESCRIPTION: FIRST MSPA RE-SUBMITTAL			
NO. : 2	DATE: 06/14/2019	BY: JLW	
DESCRIPTION: SECOND MSPA TECHNICAL SUBMITTAL			
NO. : 3	DATE: -	BY: -	
DESCRIPTION: -			
NO. : 4	DATE: -	BY: -	
DESCRIPTION: -			
NO. : 5	DATE: -	BY: -	
DESCRIPTION: -			
NO. : 6	DATE: -	BY: -	
DESCRIPTION: -			
DATE: FEBRUARY 2019		SCALE: -	
PROJECT MANAGER: JLW		PROJECT NO.: -	
DRAWN BY: JLW		DRAWING FILE: -	
PROJECT:			

QUEEN OF PEACE
CATHOLIC PARISH
13120 EAST KENTUCKY AVENUE
AURORA, CO 80012

CLIENT:
ARCHDIOCESE OF DENVER
1300 S STEELE STREET
DENVER, CO 80210

TEL: (303) 722-4687


SHEET TITLE:
**PRELIMINARY
LANDSCAPE DETAILS**

SHEET NUMBER:


7 OF 8

QUEEN OF PEACE CATHOLIC PARISH
LOT 1, BLOCK 13, AURORA HILLS, FILING NO. 9,
CITY OF AURORA, ARAPAHOE COUNTY, STATE OF COLORADO.
RECEPTION NO. 933522 RECORDED ON OCTOBER 16 1964.


MAJOR SITE PLAN AMENDMENT

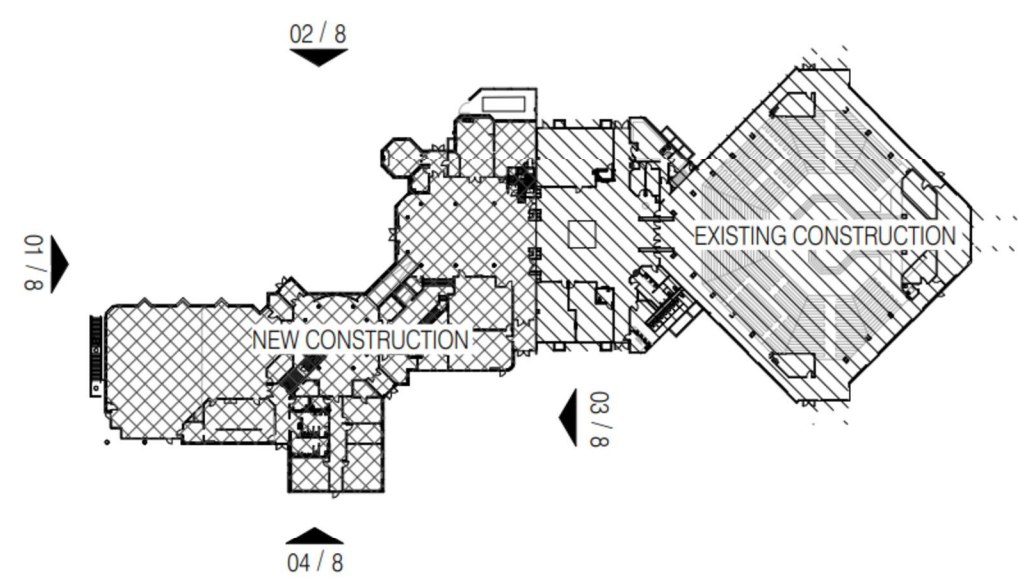


08 KEY PLAN
1" = 100'-0"

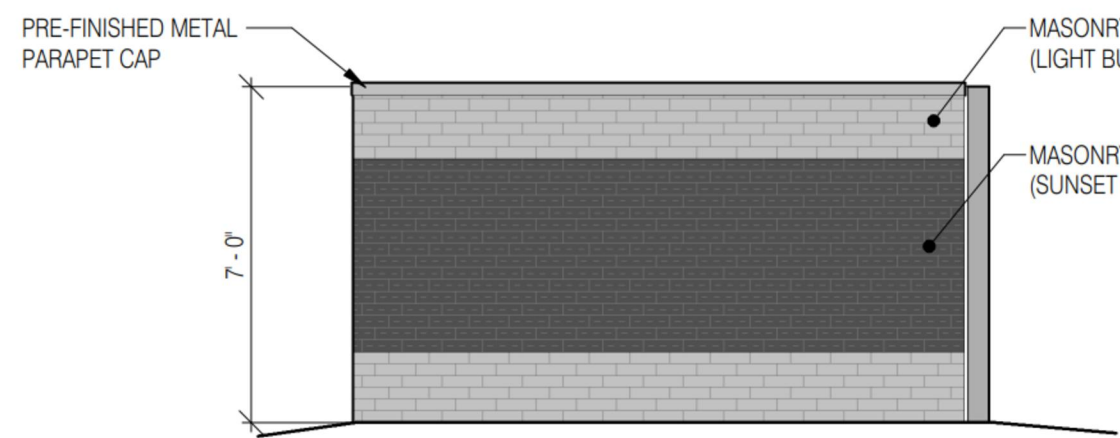


07 ENCLOSURE SOUTH ELEVATION
1/4" = 1'-0"

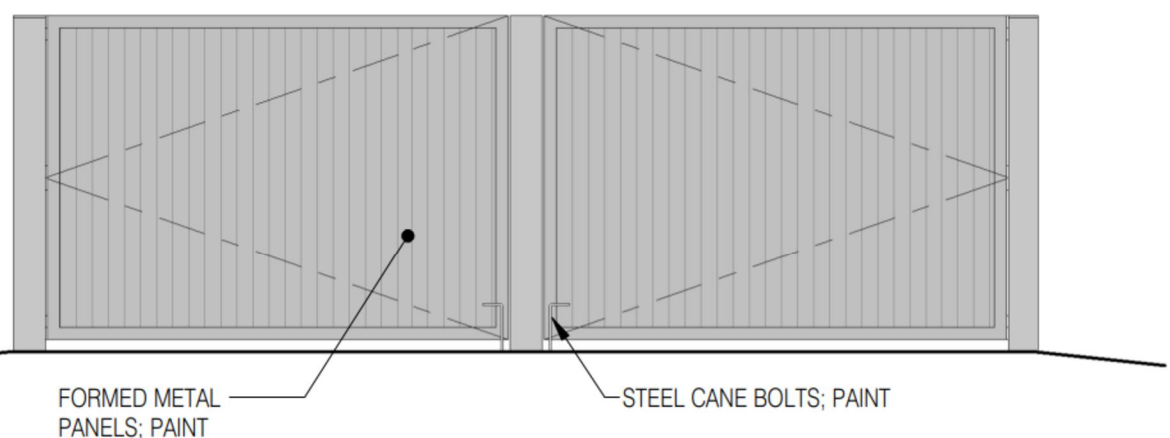


06 ENCLOSURE EAST ELEVATION
1/4" = 1'-0"

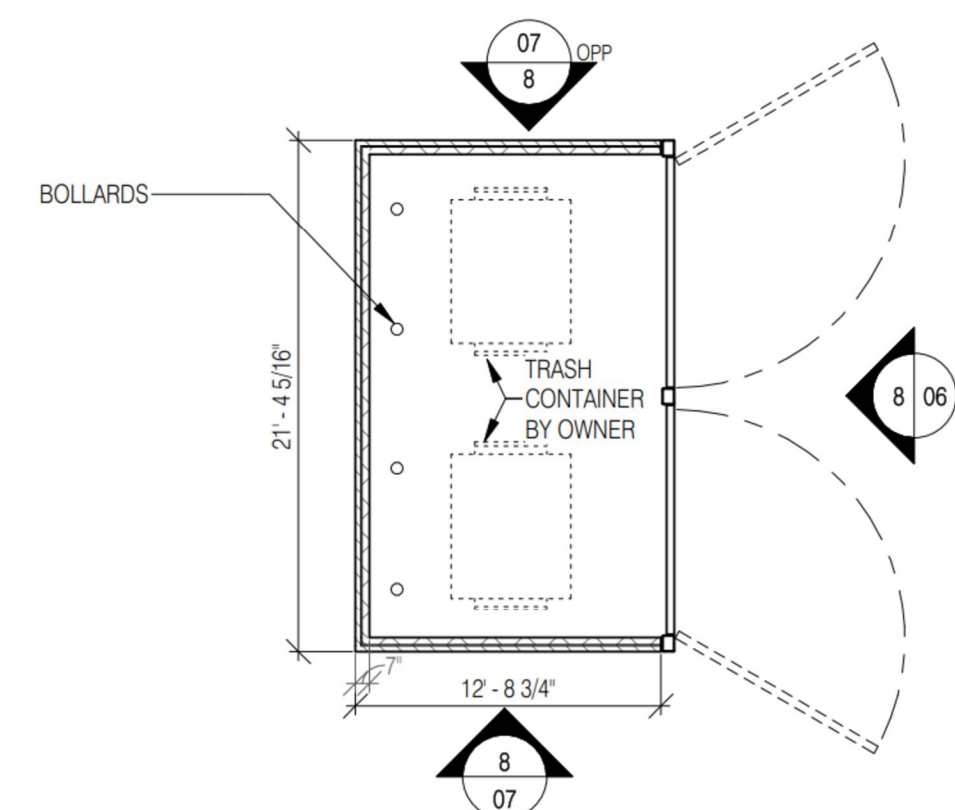


05 TRASH ENCLOSURE PLAN
1/8" = 1'-0"

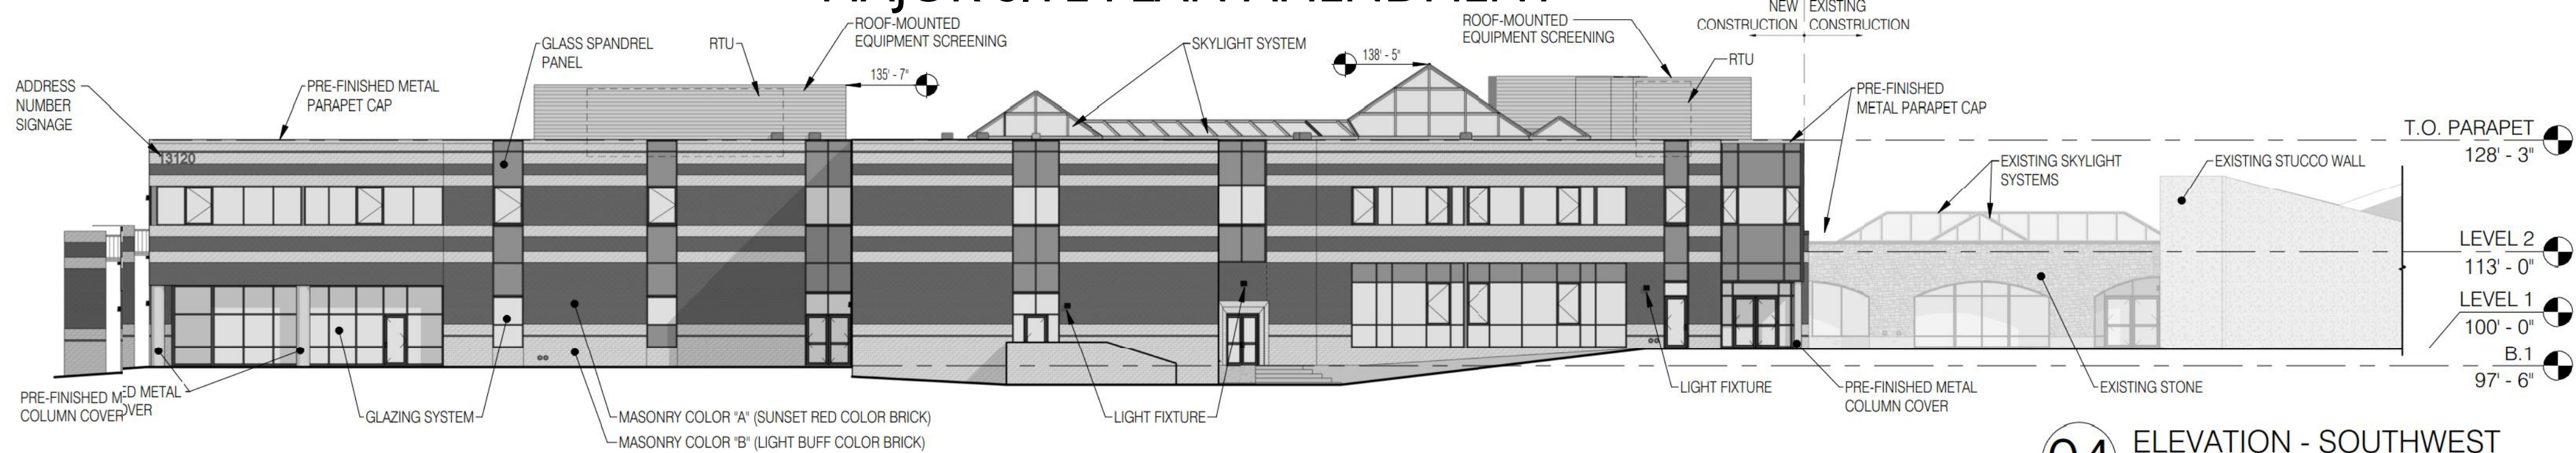


04 ELEVATION - SOUTHWEST
1/16" = 1'-0"

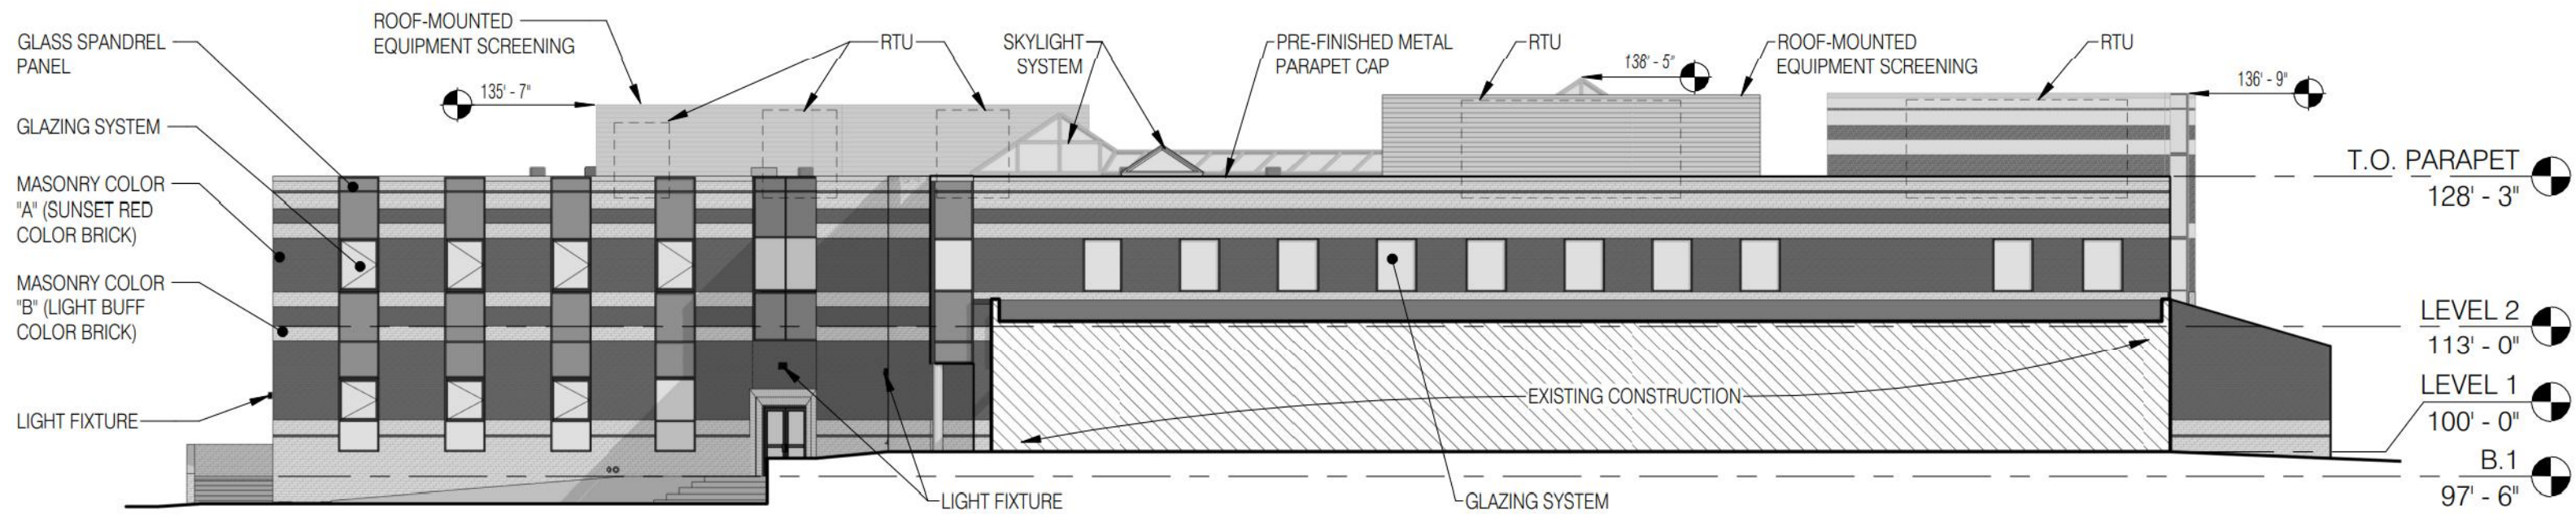

03 ELEVATION - SOUTHEAST
1/16" = 1'-0"

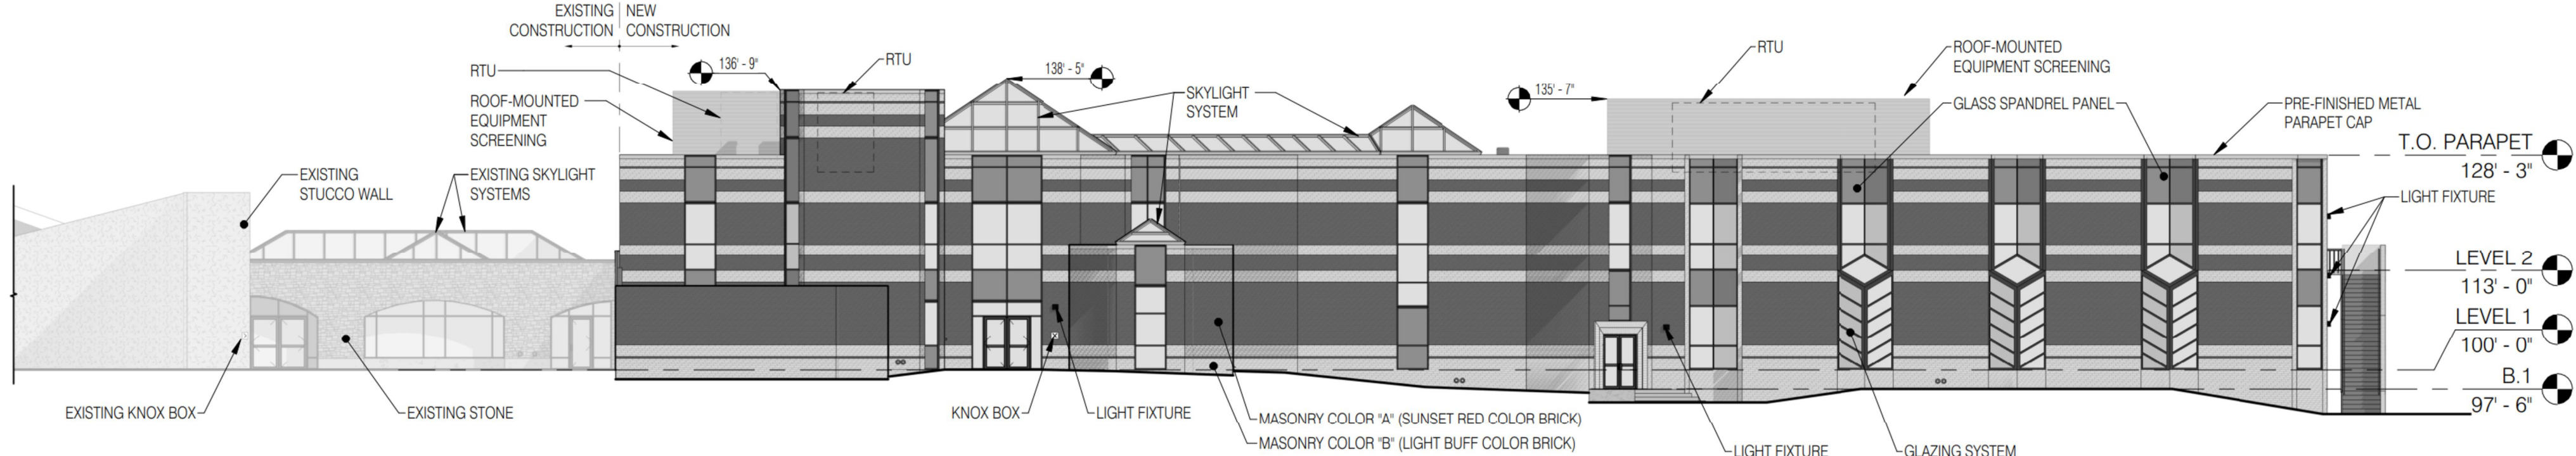

02 ELEVATION - NORTHEAST
1/16" = 1'-0"

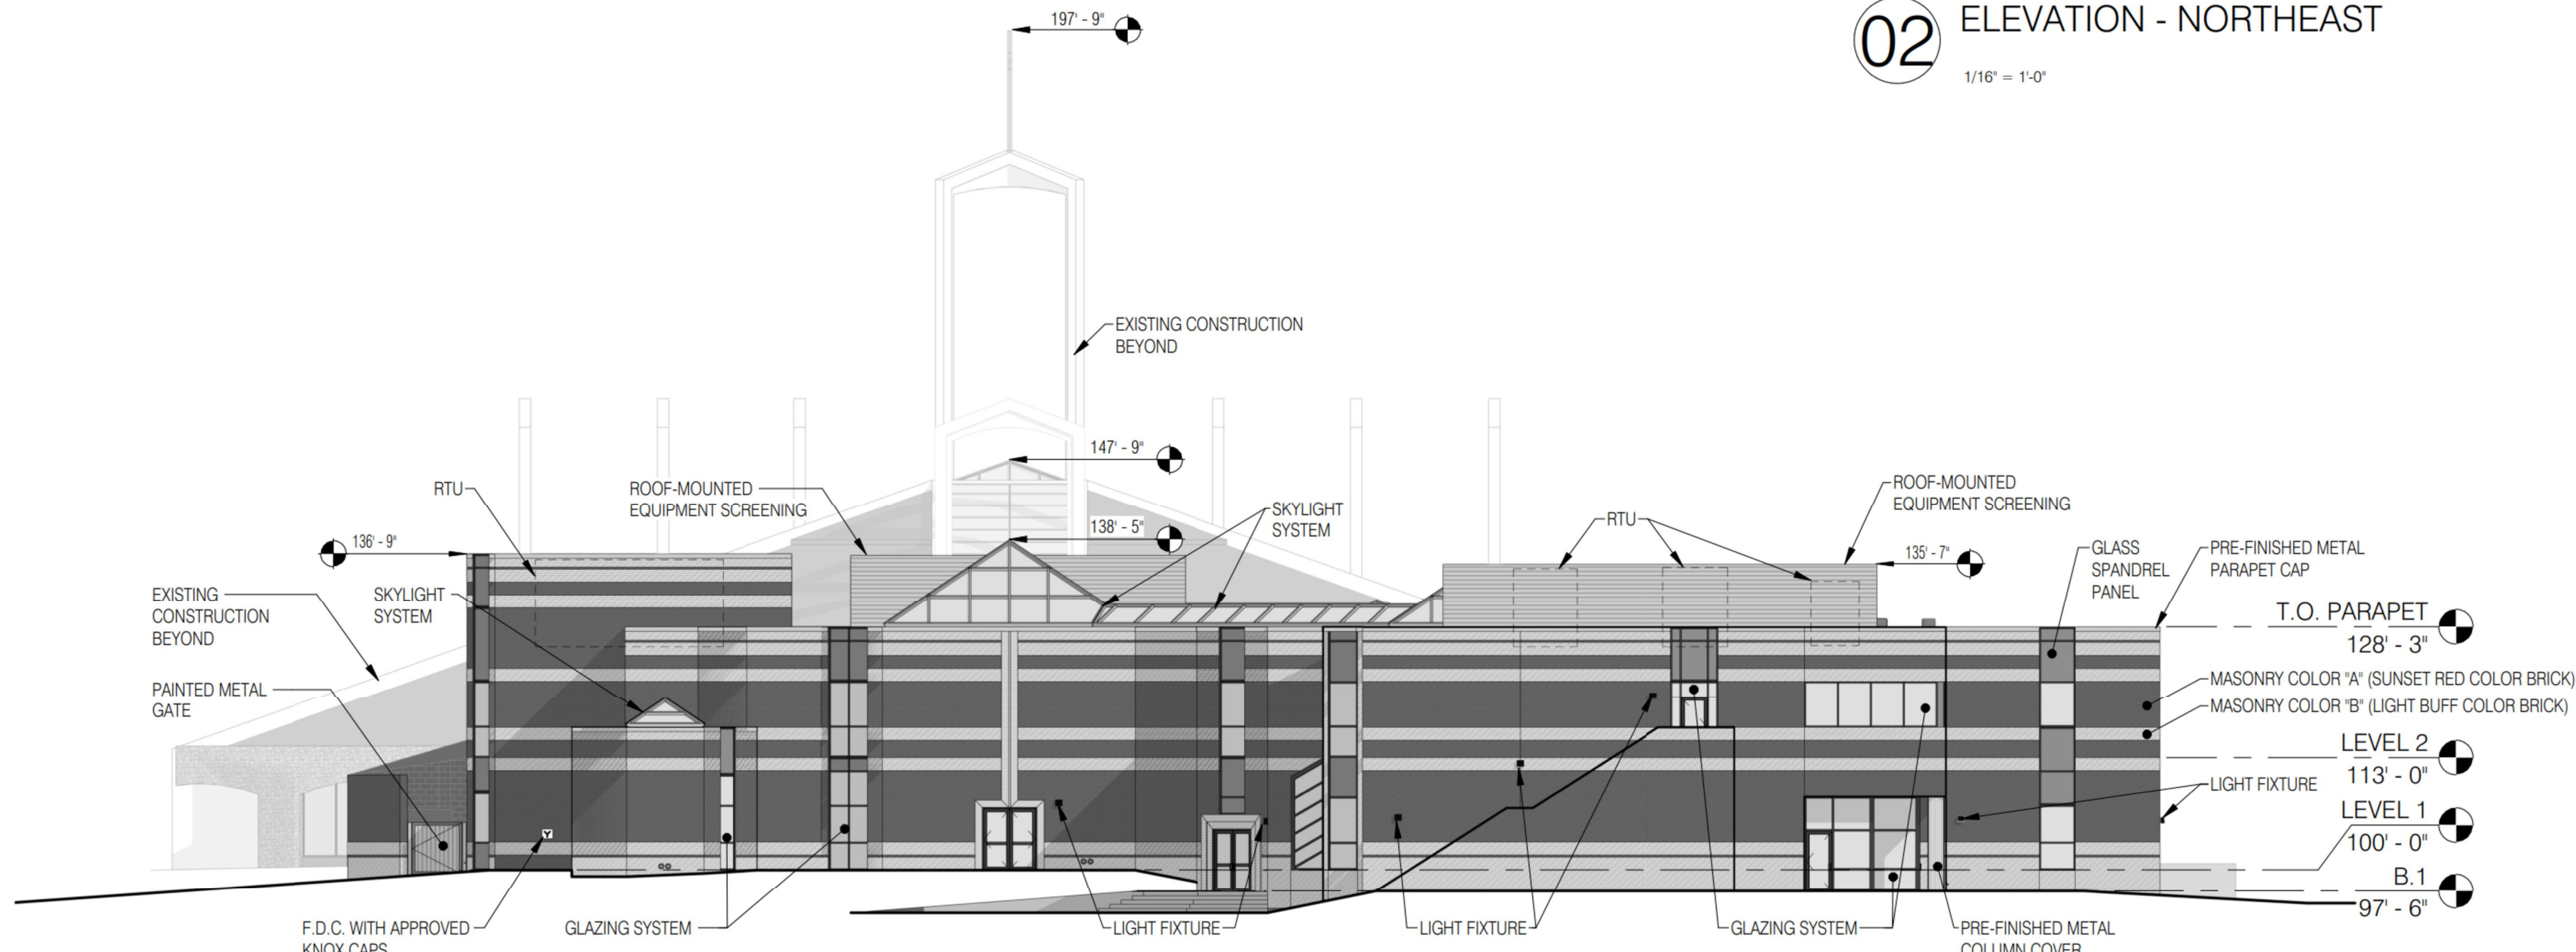

01 ELEVATION - NORTHWEST
1/16" = 1'-0"

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SHEET TITLE:
ARCHITECTURAL ELEVATIONS

SHEET NUMBER:
8 OF 8