LOTS 6, BLOCK 4, YACOVETTA SUBDIVISION SECOND FILING

PROJECT# PROJECT DATE 8/25/21 DESIGNER DRD **REVIEWER**



DENNIS RODRIGUEZ

COVER

civil ENGINEER: owner/developer Nicholas Perkins Cassinis/

brightlighter engineering llc 3253 north gaylord street denver, COLORADO 80205 epiphany developments contact: jesse donovan, pe 5000 quitman Street (720) 540-8629 denver, co 80212 jesse@brightlightereng.com (303) 859-3720 matt@epiphanydenver.com

STANDARD NOTES

1. THE DEVELOPER, HIS SUCCESSORS AND ASSIGNS, INCLUDING THE HOMEOWNERS OR MERCHANTS ASSOCIATION, SHALL BE RESPONSIBLE FOR INSTALLATION, MAINTENANCE AND REPLACEMENT OF ALL FIRE LANE SIGNS AS REQUIRED BY THE CITY OF AURORA.

2. THE DEVELOPER, HIS SUCCESSORS AND ASSIGNS, SHALL BE RESPONSIBLE FOR INSTALLATION, MAINTENANCE AND REPLACEMENT OF ALL LANDSCAPING MATERIALS SHOWN OR INDICATED ON THE APPROVED SITE PLAN OR LANDSCAPE PLAN ON FILE IN THE PLANNING

OPERATE, MAINTAIN, INSTALL, REPAIR, REMOVE OR RELOCATE ANY CITY FACILITIES LOCATED · WITHIN SAID EASEMENTS AND RIGHTS-OF-WAY AT ANY TIME AND IN SUCH A MANNER AS IT

4. ARCHITECTURAL FEATURES (I.E. BAY WINDOWS, FIREPLACES, ROOF OVERHANG, GUTTERS, EAVES, FOUNDATION, FOOTINGS, CANTILEVERED WALLS, ETC.) ARE NOT ALLOWED TO ENCROACH INTO ANY EASEMENT OR FIRE LANE.

5. THE APPROVAL OF THIS DOCUMENT DOES NOT CONSTITUTE FINAL APPROVAL OF GRADING, DRAINAGE, UTILITY, PUBLIC IMPROVEMENTS AND BUILDING PLANS. CONSTRUCTION PLANS MUST BE REVIEWED AND APPROVED BY THE APPROPRIATE AGENCY PRIOR TO THE ISSUANCE OF

6. ALL BUILDING ADDRESS NUMBERS SHALL COMPLY WITH THE AURORA CITY CODE OF ORDINANCE, CHAPTER 126 -ARTICLE VII - NUMBERING OF BUILDINGS.

7. ALL ROOFTOP MECHANICAL EQUIPMENT AND VENTS GREATER THAN EIGHT (8) INCHES IN DIAMETER MUST BE SCREENED. SCREENING MAY BE DONE EITHER WITH AN EXTENDED PARAPET WALL OR A FREESTANDING SCREEN WALL, SCREENS SHALL BE AT LEAST AS HIGH AS THE EQUIPMENT THEY HIDE. IF EQUIPMENT IS VISIBLE BECAUSE SCREENS DON'T MEET THIS MINIMUM HEIGHT REQUIREMENT, THE DIRECTOR OF PLANNING MAY REQUIRE CONSTRUCTION MODIFICATIONS PRIOR TO THE ISSUANCE OF A PERMANENT CERTIFICATE OF OCCUPANCY.

8. NOTWITHSTANDING ANY SURFACE IMPROVEMENTS, LANDSCAPING, PLANTING OR CHANGES SHOWN IN THESE SITE OR CONSTRUCTION PLANS, OR ACTUALLY CONSTRUCTED OR PUT IN PLACE, ALL UTILITY EASEMENTS MUST REMAIN UNOBSTRUCTED AND FULLY ACCESSIBLE ALONG THEIR ENTIRE LENGTH TO ALLOW FOR ADEQUATE MAINTENANCE EQUIPMENT. ADDITIONALLY, NO INSTALLATION, PLANTING, CHANGE IN THE SURFACE, ETC., SHALL INTERFERE WITH THE OPERATION OF THE UTILITY LINES PLACED WITHIN THE EASEMENT. BY SUBMITTING THESE SITE OR CONSTRUCTION PLANS FOR APPROVAL, THE LANDOWNER RECOGNIZES AND ACCEPTS THE TERMS, CONDITIONS AND REQUIREMENTS OF THIS NOTE.

9. FINAL GRADE SHALL BE AT LEAST SIX (6) INCHES BELOW ANY EXTERIOR WOOD SIDING ON THE

10. ALL INTERESTED PARTIES ARE HEREBY ALERTED THAT THIS SITE PLAN IS SUBJECT TO ADMINISTRATIVE CHANGES AND AS SHOWN ON THE ORIGINAL SITE PLAN ON FILE IN THE AURORA CITY PLANNING OFFICE AT THE MUNICIPAL BUILDING. A COPY OF THE OFFICIAL CURRENT PLAN MAY BE PURCHASED THERE. LIKEWISE, SITE PLANS ARE REQUIRED TO AGREE WITH THE APPROVED SUBDIVISION PLAT OF RECORD AT THE TIME OF A BUILDING PERMIT; AND IF NOT. MUST BE AMENDED TO AGREE WITH THE PLAT AS NEEDED, OR VICE VERSA.

11. ERRORS IN APPROVED SITE PLANS RESULTING FROM COMPUTATIONS OR INCONSISTENCIES IN THE DRAWINGS MADE BY THE APPLICANT ARE THE RESPONSIBILITY OF THE PROPERTY OWNER OF RECORD. WHERE FOUND, THE CURRENT MINIMUM CODE REQUIREMENTS WILL APPLY AT THE TIME OF BUILDING PERMIT. PLEASE BE SURE THAT ALL PLAN COMPUTATIONS ARE

12. ALL REPRESENTATIONS AND COMMITMENTS MADE BY APPLICANTS AND PROPERTY OWNERS AT PUBLIC HEARINGS REGARDING THIS PLAN ARE BINDING UPON THE APPLICANT, PROPERTY OWNER, AND ITS HEIRS, SUCCESSORS, AND ASSIGNS.

13. ARCHITECTURAL FEATURES, SUCH AS BAY WINDOWS, FIREPLACES, ROOF OVERHANGS, GUTTERS, EAVES, FOUNDATIONS, FOOTINGS, CANTILEVERED WALLS, ETC, ARE NOT ALLOWED TO ENCROACH INTO ANY EASEMENT OR FIRE LANE.

14. IN LOCATIONS WHERE UTILITY EASEMENTS OVERLAP DRAINAGE EASEMENTS, ONLY SUBSURFACE UTILITIES SHALL BE PERMITTED WITHIN THE PORTION OF THE UTILITY EASEMENT THAT OVERLAPS THE DRAINAGE EASEMENT. INSTALLATION OF ABOVE GROUND UTILITIES WITHIN A DRAINAGE EASEMENT REQUIRES PRIOR WRITTEN APPROVAL BY THE CITY ENGINEER

15. THE DEVELOPER IS RESPONSIBLE FOR SIGNING AND STRIPING ALL PUBLIC STREETS. THE DEVELOPER IS REQUIRED TO PLACE TRAFFIC CONTROL, STREET NAME, AND GUIDE SIGNS ON ALL PUBLIC STREETS AND PRIVATE STREETS APPROACHING AN INTERSECTION WITH A PUBLIC STREET. SIGNS SHALL BE FURNISHED AND INSTALLED PER THE MOST CURRENT EDITIONS OF THE MANUAL ON UNIFORM TRAFFIC CONTROL DEVICES (MUTCD) AND CITY STANDARDS AND SHOWN ON THE SIGNING AND STRIPING PLAN FOR THE DEVELOPMENT.

16. STREET TREES WILL BE ACCEPTED IF INSPECTION CONFIRMS THAT TREES HAVE BEEN PLANTED PER THE CITY STANDARD DETAIL; APPLICANT/DEVELOPER REQUIRED TO CONTACT THE CITY FOR AN INSPECTION TWO DAYS IN ADVANCE OF PLANTING. THE CITY OF AURORA FORESTRY DIVISION SHALL TAKE OWNERSHIP OF ALL STREET TREES AFTER THEY ARE PLANTED AND WILL BE RESPONSIBLE FOR THE MAINTENANCE OF THOSE TREES IN PERPETUITY - Linguis and the contract of the contract of



' 10	00' 20	00' 4	00'	600'

DATA BLOCK

- LAND AREA WITHIN PROPERTY LINES
- BUILDING TYPE NUMBER OF BUILDINGS
- BUILDING HEIGHT
- BUILDING AREA
- LANDSCAPE AREA HARD SURFACE AREA
- ZONING CLASSIFICATION
- CONSTRUCTION TYPE SPRINKLERED OR NON-SPRINKLERED
- PARKING SPACES REQUIRED
- PARKING SPACES PROVIDED
- OCCUPANCY GROUP

DUPLEX 24'-4" 1\ 1,739 SF (31.5%) (2,660 SF (48%) 1,120 SF (20%) OA-R2 (IRC TYPE V-B NON-SPRINKLERED

5,519 SF (.127 AC)

IN WITNESS THEREOF,					
((Corporation, Company, or Indivi	idual)			
HAS CAUSED THESE PRESENTS	S TO BE EXECUTED THIS	DAY OF		AD	
BY:					
(Principa	als or Owners)	_			
STATE OF COLORADO					
COUNTY OF)				
THE FOREGOING INSTRUMENT	WAS ACKNOW! EDGED BEEC	ORE ME THIS	DAY OF		ΔD
BY:					
(Principal:	s or Owners)	-			
WITNESS MY HAND AND OFFICI	AL SEAL				
(Notary Public)	·····				
MAY COMMISSION EVENES					
MY COMMISSION EXPIRES:					
					
NOTARY BUSINESS ADDRESS:					
NOTARY BUSINESS ADDRESS:	<u>APPROVALS</u>				
MY COMMISSION EXPIRES: NOTARY BUSINESS ADDRESS: _ CITY OF AURORA CITY ATTORNEY:	<u>APPROVALS</u>			ATE:	

LEGAL DESCRIPTION: LOTS 3-6, BLOCK 4, YACOVETTA SUBDIVISION SECOND FILING AND A PARCEL OF LAND LOCATED IN THE SOUTH 1/2, OF

THE SOUTHEAST 1/4, OF SECTION 3, T 4 S, R 67 W, OF THE 5TH P.M., CITY OF AURORA, COUNTY OF ARAPAHOE, STATE OF

CASSINIS DUPLEX - SITE PLAN AND REPLAT

SHEET INDEX

3 OF 5 GRADING & UTILITY PLAN 4 OF 5 LANDSCAPE PLAN

5 OF 5 BUILDING ELEVATIONS

SIGNATURE BLOCK

CITY COUNCIL:

DATABASE APPROVAL DATE:

RECORDER'S CERTIFICATE:


ACCEPTED FOR THE FILING IN THE OFFICE OF THE CLERK AND RECORDER OF _____

COLORADO AT ______ O'CLOCK _____ M,THIS _____ DAY OF ______ AD., _____

CLERK AND RECORDER: ______ DEPUTY: _____

ATTEST:

LOTS 6, BLOCK 4, YACOVETTA SUBDIVISION SECOND FILING

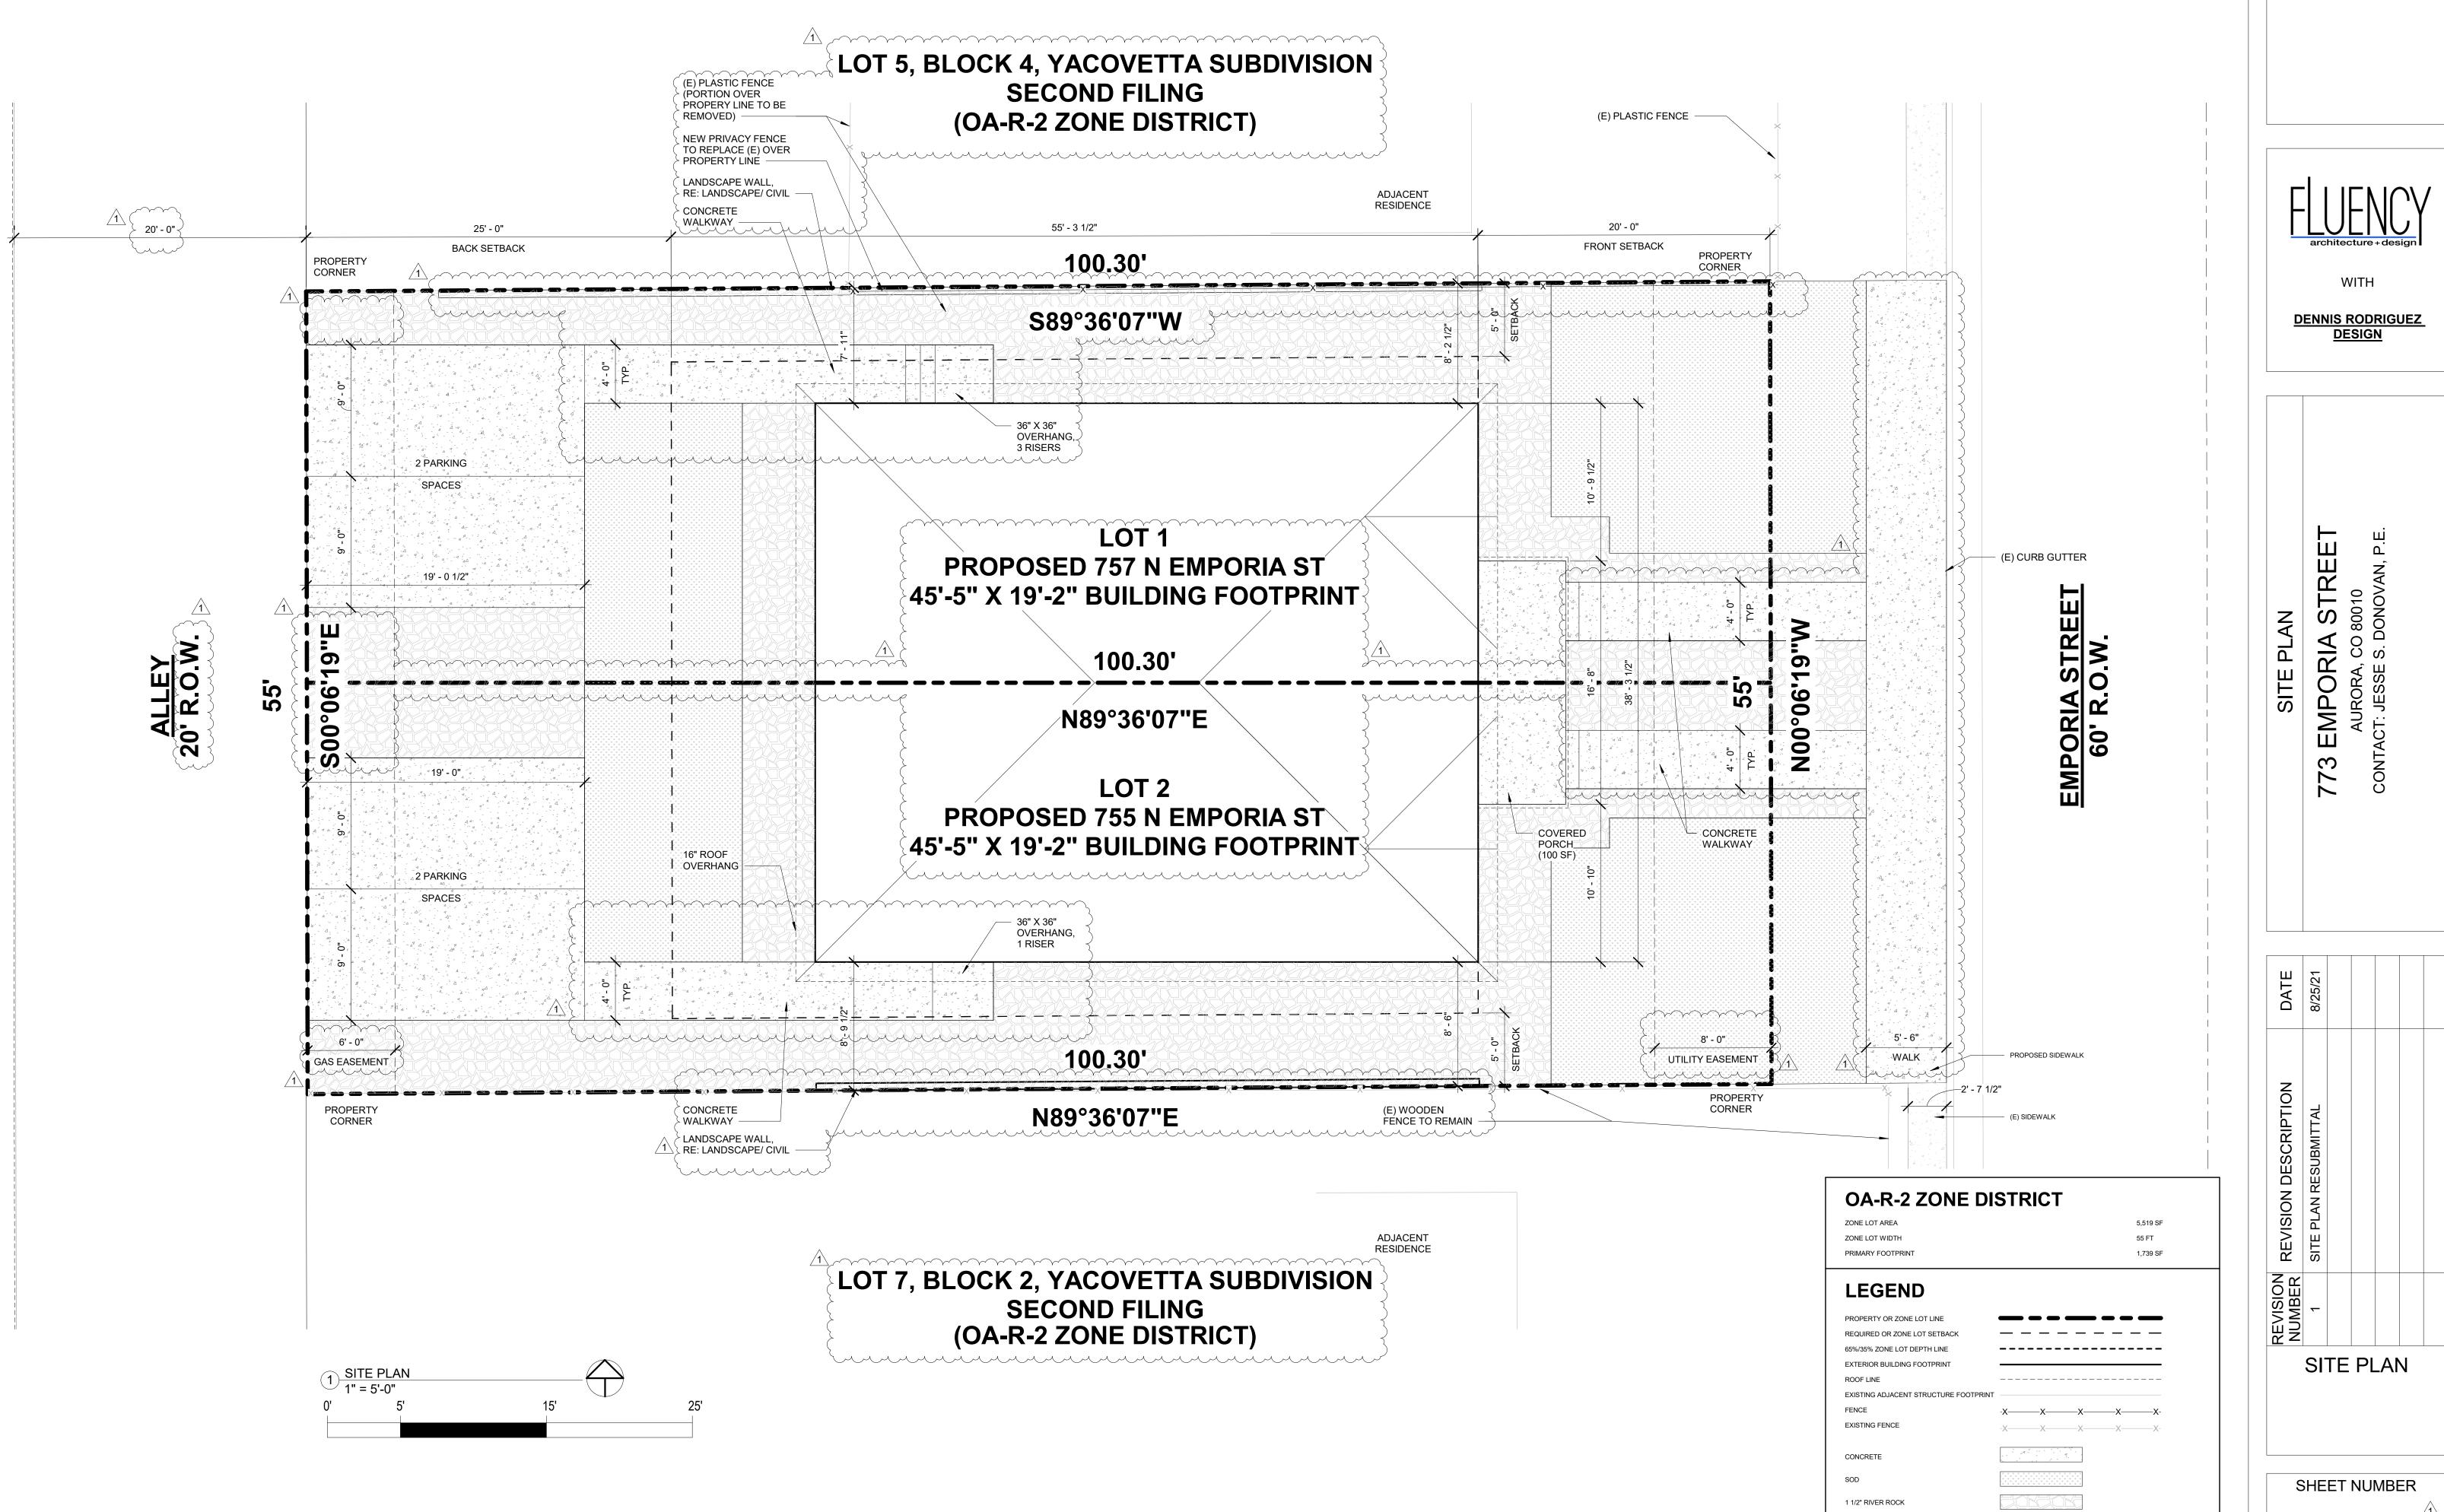


PROJECT DATE 8/25/21 DESIGNER **REVIEWER**


DATE	8/25/21					
REVISION DESCRIPTION	SITE PLAN RESUBMITTAL					
REVISION NUMBER	1					
	SI ⁻	ΤE	Ρl	_AI	٧	

2 OF 5

LOTS 6, BLOCK 4, YACOVETTA SUBDIVISION SECOND FILING

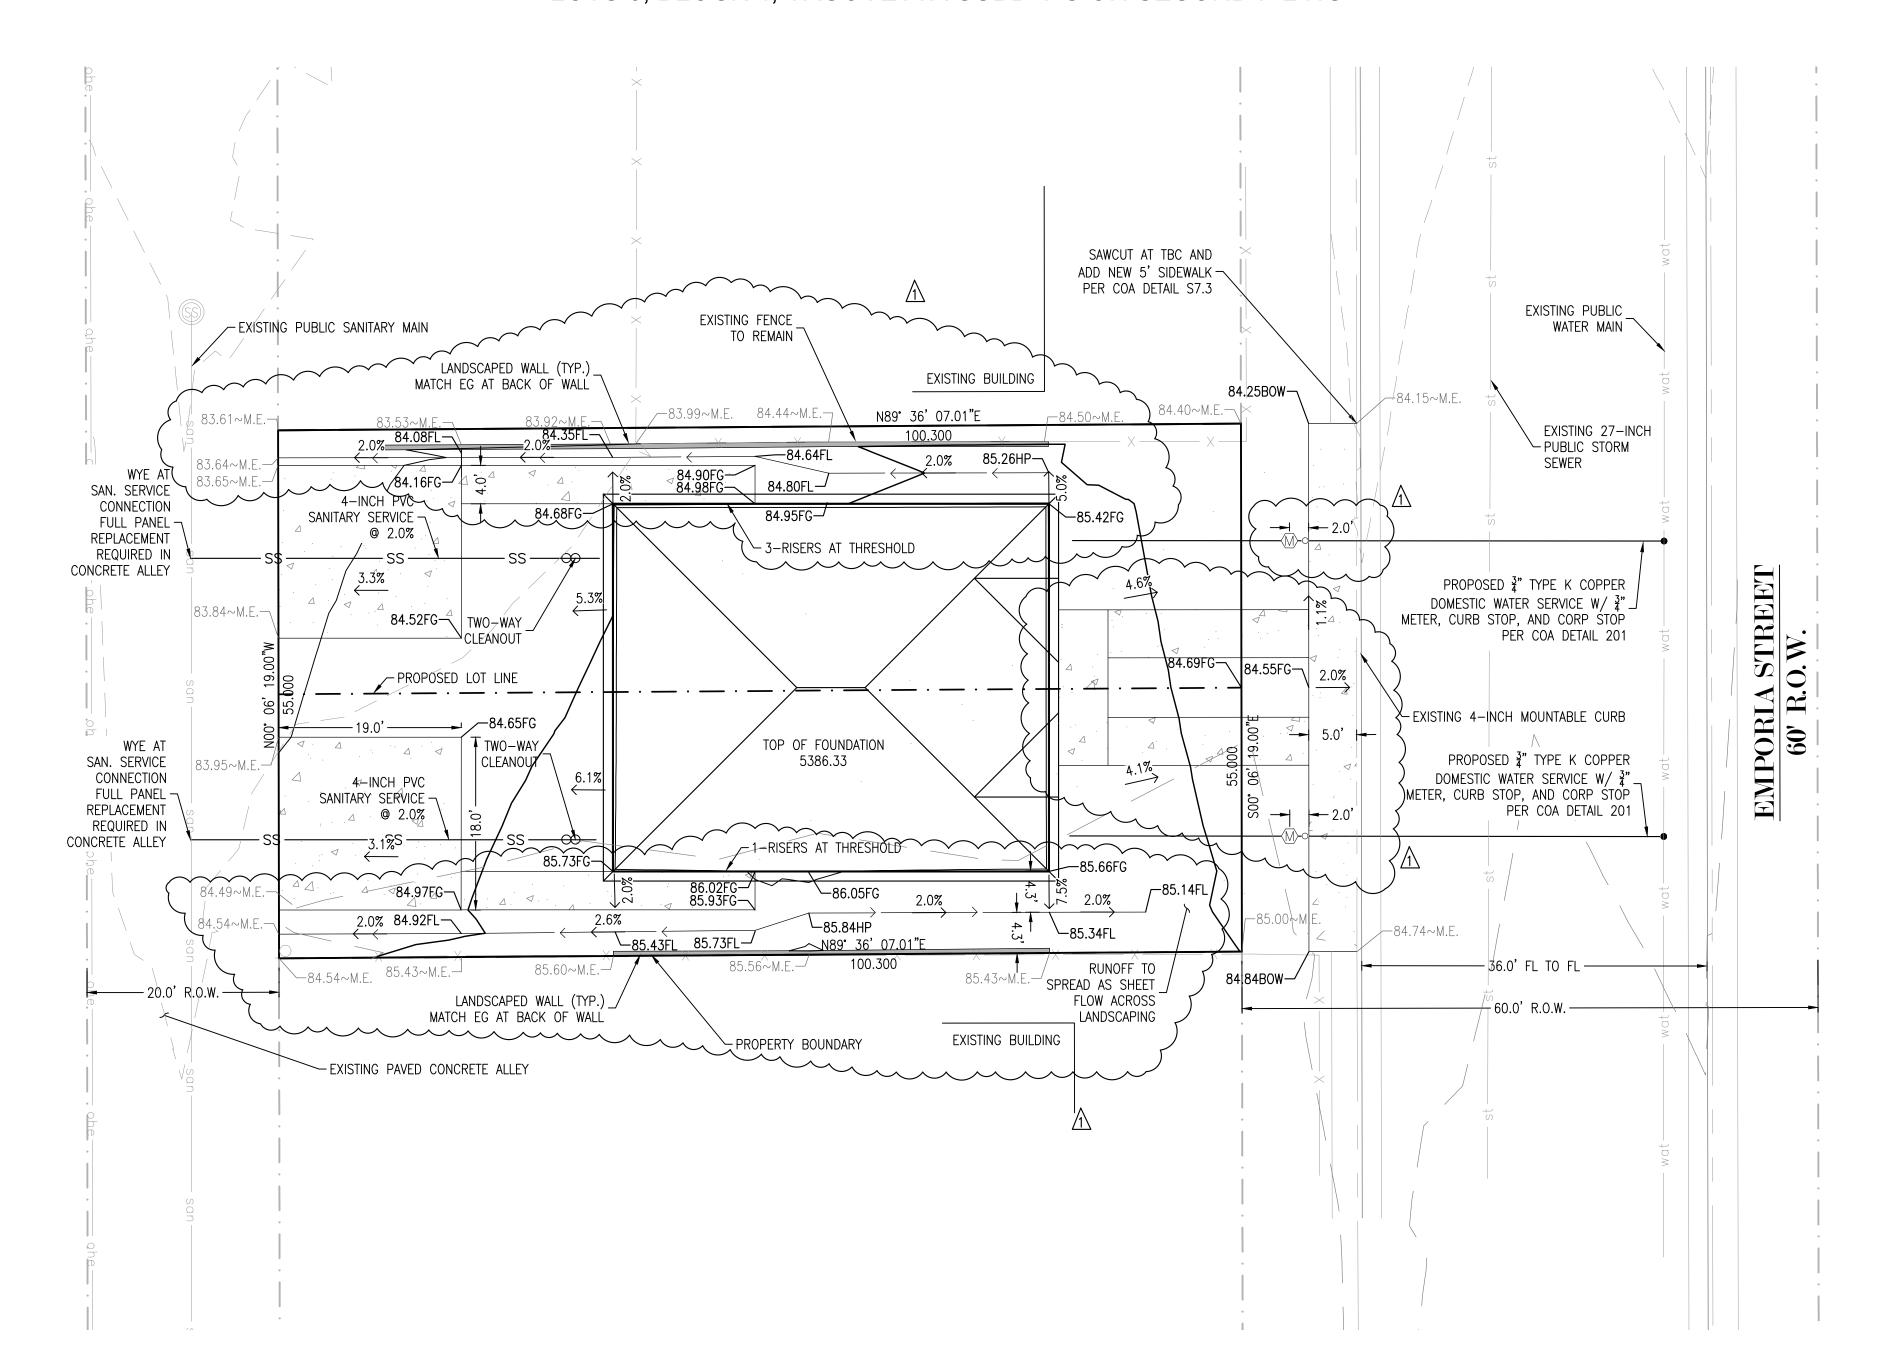

NOT FOR CONSTRUCTION

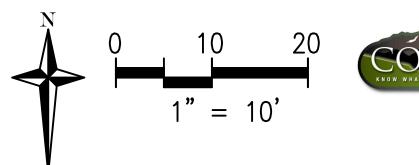

LEGEND

PROPERTY BOUNDARY EXISTING LOT LINE

PROPOSED RIGHT-OF-WAY

EXISTING RIGHT-OF-WAY

PROPOSED SETBACK LINE

PROPOSED CURB & GUTTER

EXISTING CURB & GUTTER

PROPOSED MAJOR CONTOUR

PROPOSED MINOR CONTOUR

EXISTING MAJOR CONTOUR

EXISTING MINOR CONTOUR

EXISTING PERCENT SLOPE

PROPOSED GRADE BREAK

PROPOSED DITCH FLOWLINE

EXISTING GRADE BREAK

PROPOSED PERCENT SLOPE

PROPOSED SPOT ELEVATION (SEE ABBR. LIS

EXISTING SPOT ELEVATION (SEE ABBR. LIST)

PROPOSED EASEMENT

EXISTING EASEMENT



PROJECT# ED2020 PROJECT DATE 11/04/20 DESIGNER REVIEWER JSD



STREE EMPORIA SAURORA, CO 8 FACT: JESSE S. DC SITE

CITY OF AURORA NOTES

4.0%

4.0%

23.70 **

23.70 **

FF FINISH FLOOR

FG FINISH GRADE

M.E. MATCH EXISTING

TW TOP OF WALL

TR TOP OF RISER

BR BOTTOM OF RISER

TBC TOP BACK OF CURB

FL FLOW LINE

1. IN LOCATIONS WHERE UTILITY EASEMENTS OVERLAP DRAINAGE EASEMENTS, ONLY SUBSURFACE UTILITIES SHALL BE PERMITTED WITHIN THE PORTION OF THE UTILITY EASEMENT THAT OVERLAPS THE DRAINAGE EASEMENT. INSTALLATION OF ABOVE GROUND UTILITIES WITHIN A DRAINAGE EASEMENT REQUIRES PRIOR WRITTEN APPROVAL BY THE CITY ENGINEER.

SOIL PREPARATION NOTE

SOIL PREPARATION AND PAVEMENT DESIGN SHALL BE PER RECOMMENDATIONS FROM A GEOTECHNICAL REPORT PREPARED FOR THIS SITE AS FOLLOWS:

GEOTECHNICAL ENGINEER: CUSHMAN GEOSCIENCE LLC REPORT NO: 20-128 DATED 09/30/2020

THE CONTRACTOR MUST FULLY REVIEW THIS REPORT PRIOR TO CONSTRUCTION. INFORMATION IN THE GEOTECHNICAL REPORT SUPERSEDES ANY CONFLICTING INFORMATION CONTAINED IN THE CONSTRUCTION PLANS AND SPECIFICATIONS. REFER TO GENERAL STRUCTURAL NOTES FOR SPECIFIC SOIL PREPARATION AT SITE STRUCTURES.

BENCHMARK

AURORA BENCHMARK COA I-4S6710NW001

LOWRY BOULEVARD and DAYTON STREET, EL=5384.425 3" DIAM. BRASS CAP (STAMPED COA BM, I-005A, 2004) AT THE SE CORNER OF A CONC. SEWER VAULT, BEING A PART OF THE SIDEWALK AT THE SW CORNER OF 6TH & DAYTON. 79' W OF THE W FL OF DAYTON AND

19.5' S OF THE S FL OF 6TH AVE.

LOTS 6, BLOCK 4, YACOVETTA SUBDIVISION SECOND FILING, CITY OF AURORA, COUNTY OF ARAPAHOE, STATE OF COLORADO.

DATE	08/25/21					
	8					
REVISION DESCRIPTION	SITE PLAN RESUBMITTAL					
REVISION	_					
G	GRADING AND					

SHEET NUMBER

UTILITY PLAN

3 OF 5

LOTS 6, BLOCK 4, YACOVETA SUBDIVISION SECOND FILING



DECIDUOUS SHADE TREE


ORNAMENTAL TREE

EVERGREEN SHRUB

4" CONCRETE PAVING W/ TOOLED JOINTS - TYPE II

WESTERN RED CEDAR - "GORILLA HAIR"

PLANTING LEGEND:

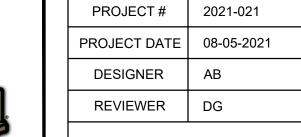



EMPORIA STREE PLAN LANDSCAPE ್ ₹


REV

LANDSCAPE PLAN

SHEET NUMBER

LOT 5 - EXISTING PLASTIC FENCE ADJACENT RESIDENCE SETBACK N89°36'07"E100.30' **PARKING** - 8 MHE 2 CSP **CONCRETE** PORCH 7 AWS PARKING 11 BAG 1 NRO WALL, RE: CIVIL **EXISTING** — 5 IDG WOOD **FENCE**

ADJACENT RESIDENCE

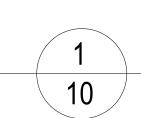

- PRUNE ONLY BROKEN AND DEAD WOOD FROM CANOPY

TRUNK. REMOVE DEBRIS FROM PLANTING HOLE.

ANY BROKEN, CRUMBLING, OR OTHERWISE DAMAGED ROOTBALL

-UNDISTURBED SUBGRADE.

SHALL NOT BE PLANTED.

LANDSCAPE PLAN

SCALE: 1"= 10'

PER INDUSTRY BEST MANAGEMENT PRACTICES. -DECIDUOUS TREE FALL PLANTING: WRAP TRUNK TO FIRST BRANCH WITH SPECIFIED TREE WRAP MATERIAL. SECURE AT TOP WITH MASKING TAPE. DO NOT WRAP ROUGH BARK TREES. REMOVE TRUNK WRAP IN SPRING AFTER LAST -12" NYLON TREE STRAP WITH GROMMETS ON GUY WIRE. DO NOT TWIST STRAPS TIGHT AROUND TRUNK. -1/2" DIAMETER WHITE PVC PIPE SECTION ON ENTIRE LENGTH OF EACH WIRE. -14-GAUGE GALVANIZED WIRE, DOUBLE STRAND. LEAVE 1" TO 2" SLACK IN WIRE TO ALLOW FOR TRUNK MOVEMENT. IF NEEDED, 6' STEEL POST OR WOOD STAKE, BOTH WITH SAFETY CAPS. SET ONE POST TO WINDWARD SIDE AND OTHER OPPOSITE. INSTALL POSTS TO 2' DEPTH IN UNDISTURBED SUBGRADE, AND ADD SAFETY CAPS. OTHER STAKING METHODS MUST BE PRE-APPROVED. OPEN TOP OF BURLAP AND CAREFULLY REMOVE SOIL FROM TOP OF ROOT BALL TO EXPOSE ROOT FLARE TO TOP OF FIRST ORDER ROOTS. SET TOP OF ROOT FLARE/FIRST ORDER ROOTS AT OR 1" TO 2" ABOVE FINISH GRADE. PRUNE ADVENTITIOUS ROOTS ON TRUNK. CIRCLE OF SHREDDED WOOD MULCH, 3" DEEP AND 4" TO 6" AWAY FROM TRUNK, 5' DIAMETER OR TO OUTER EDGE OF PLANTING HOLE, WHICHEVER IS GREATER. FORM 2" HIGH SOIL SAUCER AROUND PLANTING HOLE AT OUTSIDE OF TRANSITION ZONE. -NATIVE SOIL OR AMENDED PER SOIL TEST RECOMMENDATIONS. SLOPE SIDES OF PLANTING HOLE, SCARIFY AND ROUGHEN SIDES PRIOR TO INSTALLING TREE. PRIOR TO PLACING ROOT BALL IN PLANTING HOLE, REMOVE ALL TWINE AND BOTTOM 1/4 OF WIRE BASKET. CAREFULLY PLACE ROOT BALL INTO PLANTING HOLE, SET IN FINAL LOCATION, AND REMOVE REMAINING WIRE. CUT AND GENTLY REMOVE MIN. 2/3 OF BURLAP FROM TOP AND SIDES OF ROOT 2X ROOT BALL DIAMETER BALL. PRUNE CIRCLING OR GIRDLING ROOTS AT AND ON OUTSIDE OF ROOT BALL TO PERPENDICULAR ANGLE FROM

REMOVE ONLY INJURED OR DEAD BRANCHES FROM SHRUBS. SHRUB

SPACING AS PER PLANS, LAYOUT

PLACE 3' DIA. MIN. RING OF MULCH

UNDER SHRUB

OF THE ROOTBALL

REMOVE CONTAINER OR

COMPLETELY /PEEL BACK, CUT AND REMOVE 1/3rd OF THE BURLAP. REMOVE ALL ROPE,

TWINE AND WIRE. SET ROOTBALL PLUMB IN CENTER OF PIT WITH TOP OF ROOTBALL 2" ABOVE

FINISH GRADE. BANK SOIL TO TOP

REMOVE DISH WHEN READY TO

PREPARE AND PLACE PLANTING

SET ROOTBALL ON UNDISTURBED

SOIL MIX AS PER SPEC.

COMPACTED SUBGRADE

SHRUB PLANTING DETAIL

SCALE: 1/2"= 1'-0"

3-4 X ROOT BALL DIAMETER

SCALE: 1/2"= 1'-0"

TREE PLANTING DETAIL

2X ROOTBALL

DIA. MIN.

SOD OR SEED. CONDITION VARIES.

PLANTING SCHEDULE:

				1				
KEY	BOTANICAL NAME	COMMON NAME	QUANTITY	SIZE	SPACING	HEIGHT	WIDTH	WATER
DECID	UOUS SHADE TREES					-		
NR0	Quercus rubra	Northern Red Oak	1	2.5" cal.	as shown	40-60'	40-60'	L - M
ORNAI	MENTAL TREES					•		
CSP	Pyrus calleryana 'Cleveland Select'	Cleveland Select Pear	2	2.5" cal.	as shown	20-30'	15-20'	M
EVERG	GREEN SHRUBS					•		
MHE	Euonymus kiautschovica 'Manhattan'	Manhattan Euonymus	8	5' o.c.	4-6'	6-8'	M	
DMP	Pinus mugo 'Pumilo'	Dwarf Mugo Pine	10	#5	4' o.c.	3-4'	3-4'	L
DECID	UOUS SHRUBS							
IDG	Cornus sericea 'Isanti'	Isanti Dogwood	10	#5	4' o.c.	4-6'	4'	M
PBS	Prunus besseyi 'Pawnee Buttes'	Pawnee Buttes Sand Cherry	12	#5	3.5' o.c.	1-2'	4-6'	М
AWS	Spiraea bumalda	Anthony Waterer Spirea	6	#5	3' o.c.	2-3'	2-3'	M
ORNAI	MENTAL GRASSES							
BAG	Helictotrichon sempervirens	Blue Avena Grass	22	#1	24" o.c.	2-3'	2'	M

LANDSCAPE NOTES:

- 1. ALL UTILITY EASEMENTS SHALL REMAIN UNOBSTRUCTED AND FULLY ACCESSIBLE ALONG THEIR ENTIRE LENGTH FOR MAINTENANCE EQUIPMENT ENTRY.
- 2. THE DEVELOPER AND HIS SUCCESSORS AND ASSIGNS, SHALL BE RESPONSIBLE FOR INSTALLATION, MAINTENANCE AND REPLACEMENT OF ALL LANDSCAPING MATERIALS SHOWN OR INDICATED ON THE APPROVED SITE PLAN OR LANDSCAPE PLAN ON FILE IN THE PLANNING DEPARTMENT. ALL LANDSCAPING WILL BE INSTALLED AS DELINEATED IN THE PLAN, PRIOR TO ISSUANCE OF CERTIFICATES OF OCCUPANCY.
- 3. ALL LANDSCAPED AREAS AND PLANT MATERIAL, EXCEPT FOR NON-IRRIGATED NATIVE, RESTORATIVE AND DRYLAND GRASS AREAS MUST BE WATERED BY AN AUTOMATIC UNDERGROUND IRRIGATION SYSTEM. IRRIGATION SYSTEM DESIGN, INSTALLATION, OPERATION AND MAINTENANCE SHALL CONFORM TO REQUIREMENTS FOUND IN THE CITY OF AURORA IRRIGATION ORDINANCE.
- 4. INSTALL SOIL AMENDMENTS AT A MINIMUM RATIO OF 4 CUBIC YARDS OF ORGANIC MATTER OR COMPOST PER 1,000 S.F. OF SOIL AND TILLED TO A DEPTH OF AT LEAST SIX INCHES ON ALL LANDSCAPE AREAS NOT COVERED BY IMPERVIOUS SURFACES AND PERMEABLE PAVING
- 5. NO FREE STANDING LIGHTS WILL BE PRESENT ON SITE.
- 6. ALL WALKS, DRIVEWAYS, CURB AND GUTTER AND PATIOS SHALL BE CONCRETE.
- 7. ALL PLANTING BEDS TO BE MULCHED TO A DEPTH OF 3" WITH WESTERN RED CEDAR MULCH.

OA-R2 ZONE DISTRICT:

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MATERIAL LEGEND:

ZO	NE LOT AREA	5,519 SF
ZO	NE LOT WIDTH	55'
PRI	MARY FOOTPRINT	1,739 SF

PROPERTY LINE

RETAINING WALL

FINISH: LIGHT BROOM


MULCH - TYPE I

MULCH - TYPE II


1.5" RIVER ROCK

RE: CIVIL

EDGER

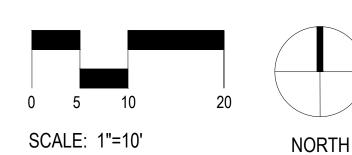

LOTS 6, BLOCK 4, YACOVETTA SUBDIVISION SECOND FILING

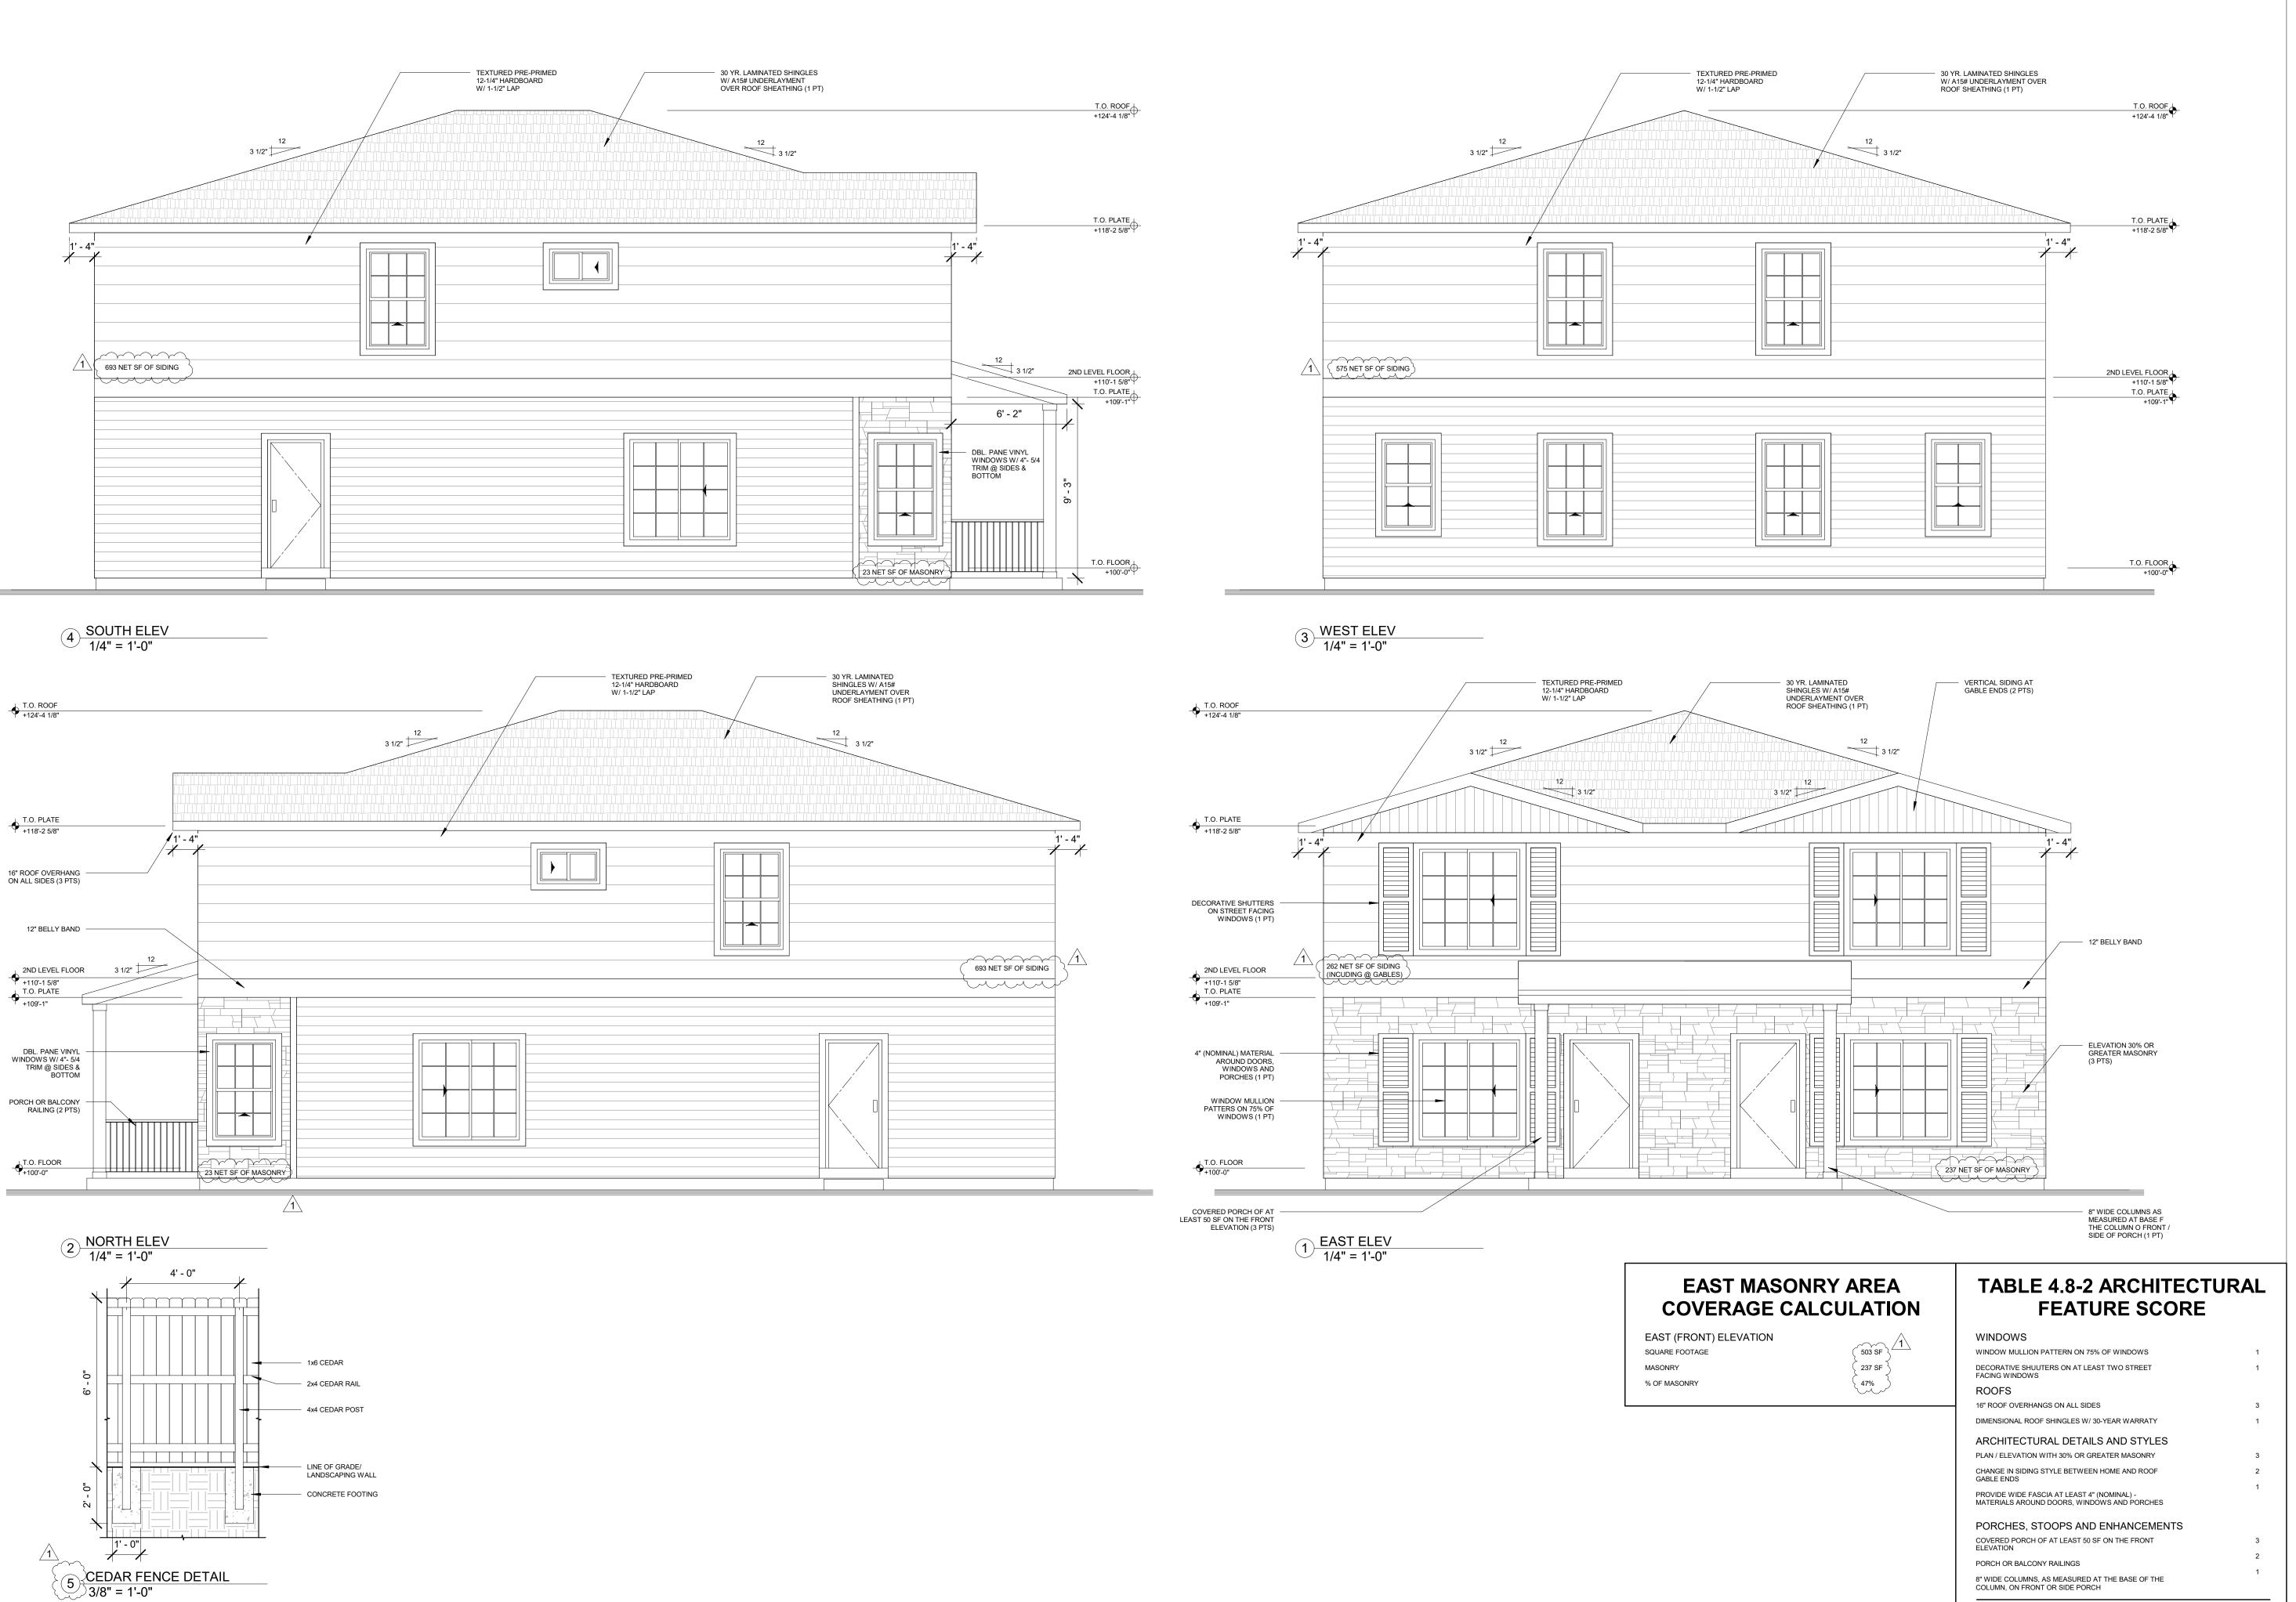

PROJECT # 21030

PROJECT DATE 8/25/21

DESIGNER DRD

REVIEWER SAH



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DENNIS RODRIGUEZ
DESIGN

SITE PLAN

EMPORIA STREET

AURORA, CO 80010

ACT: JESSE S. DONOVAN, P.E.

3

EVISION REVISION DESCRIPTION DATE

1 SITE PLAN RESUBMITTAL 8/25/21

ELEVATIONS

SHEET NUMBER

5 OF 5

TOTAL