



LATITUDE: N 39° 37' 30.62" (NAD 83)
 LONGITUDE: W 104° 49' 22.04" (NAD 83)
 ELEVATION: 5,692.52' (NAD 88)
 COORDINATES AND ELEVATION PROVIDED FROM SURVEY COMPLETED BY ALTURA LAND
 CONSULTANTS, DATED 7/19/18.

FROM SPRINT OFFICE:

1. TAKE S HAVANA RD NORTH AND TURN RIGHT ONTO ARAPAHOE RD
2. TAKE ARAPAHOE RD TO PARKER RD AND GO NORTH
3. TAKE PARKER RD NORTH TO E BELLEVUE AVE AND GO LEFT
4. SITE LOCATION IS THE BUILDING TO THE NORTH

DRIVING DIRECTIONS

AREA OF CONSTRUCTION:	144 SF
ZONING:	COMMERCIAL
PARCEL ID:	2073-07-3-36-001
JURISDICTION:	ARAPAHOE COUNTY
SPECIAL ACCESS ISSUES:	-
STRUCTURE HEIGHT:	32'-0"
ANTENNA CL:	VARIES

SITE INFORMATION

PROJECT INFORMATION:

SCOPE OF WORK:

INSTALL (2) CUPOLAS / PENTHOUSES
INSTALL (6) PANEL ANTENNAS
INSTALL (9) RRU
INSTALL (1) SHROUDED ANTENNA MOUNT
INSTALL (5) CABINETS: ECAB, BCAB, CABLING, FIBER AND PPC
INSTALL EQUIPMENT PLATFORM
INSTALL 10'-0" x 10'-0" CONCRETE PAD
INSTALL MASONRY WALL W/GATE

PROJECT SUMMARY

ALL WORK AND MATERIALS SHALL BE PERFORMED AND INSTALLED IN ACCORDANCE WITH THE CURRENT EDITIONS OF THE FOLLOWING CODES AS ADOPTED BY THE LOCAL GOVERNING AUTHORITIES. NOTHING IN THESE PLANS IS TO BE CONSTRUED TO PERMIT WORK NOT CONFORMING TO THE LATEST EDITIONS OF THE FOLLOWING:

1. INTERNATIONAL BUILDING CODE, (2015 EDITION)	4. NATIONAL ELECTRIC CODE, (2015 EDITION)
2. LOCAL BUILDING CODE	5. ANSI/TIA/EIA-222-G
3. CITY/COUNTY ORDINANCES	



CIVIL ENGINEER:

NAME:	TOWER ENGINEERING PROFESSIONALS
ADDRESS:	500 E. 84TH AVE., SUITE C10
CITY, STATE, ZIP:	THORNTON, CO 80229
CONTACT:	NICHOLAS M. CONSTANTINE, P.E.
PHONE:	(303) 566-9914

SITE APPLICANT:

NAME:	SPRINT
CONTACT:	DAWN SMITH
ADDRESS:	333 INVERNESS DR S
CITY, STATE, ZIP:	ENGLEWOOD, CO 80112
PHONE:	(303) 883-3400

CONSTRUCTION MANAGER:
NAME: MASTEC NETWORK SOLUTIONS
CONTACT: RYAN PRUETTE
PHONE: (720) 585-4994

PROPERTY OWNER:

NAME:	CHASE ADAM LLC, SMOKY HILL LLC
ADDRESS:	6182 LEMON GULCH DR
CITY, STATE, ZIP:	CASTLE ROCK, CO, 80108
CONTACT:	WES BACKER
PHONE:	(303) 841-2400

PROJECT TEAM

PLANS PREPARED FOR:

APPROVER	SIGNATURE	DATE
SITE ACQ. MANAGER		
CONSTRUCTION MNG		
A&E MANAGER		
PLANNING CONS.		
RF MANAGER		
RF ENGINEER		
PROPERTY OWNER		

[illegible]

PLANS PREPARED BY:

0	07-24-18	ZONING
REV	DATE	ISSUED FOR:
DRAWN BY: BRC		CHECKED BY: ARB

PRELIMINARY
DO NOT USE FOR
CONSTRUCTION

SHEET NUMBER: T-1	REVISION: 0
	TEP #:134006.202215

GENERAL NOTES:

1.

ALL REFERENCES TO OWNER IN THESE DOCUMENTS SHALL BE CONSIDERED SPRINT OR ITS DESIGNATED REPRESENTATIVE.
2.

ALL WORK PRESENTED ON THESE DRAWINGS MUST BE COMPLETED BY THE CONTRACTOR UNLESS NOTED OTHERWISE. THE CONTRACTOR MUST HAVE CONSIDERABLE EXPERIENCE IN PERFORMANCE OF WORK SIMILAR TO THAT DESCRIBED HEREIN. BY ACCEPTANCE OF THIS ASSIGNMENT, THE CONTRACTOR IS ATTESTING THAT HE DOES HAVE SUFFICIENT EXPERIENCE AND ABILITY, THAT HE IS KNOWLEDGABLE OF THE WORK TO BE PERFORMED AND THAT HE IS PROPERLY LICENSED AND PROPERLY REGISTERED TO DO THIS WORK IN THE STATE OF COLORADO.
3.

STRUCTURE IS DESIGNED IN ACCORDANCE WITH ANSI/TIA/EIA-222-G, 2005, FOR A 90 MPH 3-SECOND GUST WIND LOAD. THIS CONFORMS TO THE REQUIREMENTS OF THE INTERNATIONAL BUILDING CODE, 2015 EDITION.
4.

WORK SHALL BE COMPLETED IN ACCORDANCE WITH THE INTERNATIONAL BUILDING CODE, 2015 EDITION.
5.

UNLESS SHOWN OR NOTED OTHERWISE ON THE CONTRACT DRAWINGS, OR IN THE SPECIFICATIONS, THE FOLLOWING NOTES SHALL APPLY TO THE MATERIALS LISTED HEREIN, AND TO THE PROCEDURES TO BE USED ON THIS PROJECT.
6.

ALL HARDWARE ASSEMBLY MANUFACTURER’S INSTRUCTIONS SHALL BE FOLLOWED EXACTLY AND SHALL SUPERCEDE ANY CONFLICTING NOTES ENCLOSED HEREIN.
7.

IT IS THE CONTRACTOR’S SOLE RESPONSIBILITY TO DETERMINE ERECTION PROCEDURE AND SEQUENCE TO ENSURE THE SAFETY OF THE STRUCTURE AND IT’S COMPONENT PARTS DURING ERECTION AND/OR FIELD MODIFICATIONS. THIS INCLUDES, BUT IS NOT LIMITED TO, THE ADDITION OF TEMPORARY BRACING, GUYS OR TIE DOWNS THAT MAY BE NECESSARY. SUCH MATERIAL SHALL BE REMOVED AND SHALL REMAIN THE PROPERTY OF THE CONTRACTOR AFTER THE COMPLETION OF THE PROJECT.
8.

ALL DIMENSIONS, ELEVATIONS, AND EXISTING CONDITIONS SHOWN ON THE DRAWINGS SHALL BE FIELD VERIFIED BY THE CONTRACTOR PRIOR TO BEGINNING ANY MATERIALS ORDERING, FABRICATION OR CONSTRUCTION WORK ON THIS PROJECT. CONTRACTOR SHALL NOT SCALE CONTRACT DRAWINGS IN LIEU OF FIELD VERIFICATIONS. ANY DISCREPANCIES SHALL BE IMMEDIATELY BROUGHT TO THE ATTENTION OF THE OWNER AND THE OWNER’S ENGINEER. THE DISCREPANCIES MUST BE RESOLVED BEFORE THE CONTRACTOR IS TO PROCEED WITH THE WORK. THE CONTRACT DOCUMENTS DO NOT INDICATE THE METHOD OF CONSTRUCTION. THE CONTRACTOR SHALL SUPERVISE AND DIRECT THE WORK AND SHALL BE SOLELY RESPONSIBLE FOR ALL CONSTRUCTION MEANS, METHODS, TECHNIQUES, SEQUENCES, AND PROCEDURES. OBSERVATION VISITS TO THE SITE BY THE OWNER AND/OR THE ENGINEER SHALL NOT INCLUDE INSPECTION OF THE PROTECTIVE MEASURES OR THE PROCEDURES.
9.

ALL MATERIALS AND EQUIPMENT FURNISHED SHALL BE NEW AND OF GOOD QUALITY, FREE FROM FAULTS AND DEFECTS AND IN CONFORMANCE WITH THE CONTRACT DOCUMENTS. ANY AND ALL SUBSTITUTIONS MUST BE PROPERLY APPROVED AND AUTHORIZED IN WRITING BY THE OWNER AND ENGINEER PRIOR TO INSTALLATION. THE CONTRACTOR SHALL FURNISH SATISFACTORY EVIDENCE AS TO THE KIND AND QUALITY OF THE MATERIALS AND EQUIPMENT BEING SUBSTITUTED.
10.

THE CONTRACTOR SHALL BE RESPONSIBLE FOR INITIATING, MAINTAINING, AND SUPERVISING ALL SAFETY PRECAUTIONS AND PROGRAMS IN CONNECTION WITH THE WORK. THE CONTRACTOR IS RESPONSIBLE FOR ENSURING THAT THIS PROJECT AND RELATED WORK COMPLIES WITH ALL APPLICABLE LOCAL, STATE, AND FEDERAL SAFETY CODES AND REGULATIONS GOVERNING THIS WORK.
11.

ACCESS TO THE PROPOSED WORK SITE MAY BE RESTRICTED. THE CONTRACTOR SHALL COORDINATE INTENDED CONSTRUCTION ACTIVITY, INCLUDING WORK SCHEDULE AND MATERIALS ACCESS, WITH THE RESIDENT LEASING AGENT FOR APPROVAL.
12.

BILL OF MATERIALS AND PART NUMBERS LISTED ON CONSTRUCTION DRAWINGS ARE INTENDED TO AID CONTRACTOR. CONTRACTOR SHALL VERIFY PARTS AND QUANTITIES WITH MANUFACTURER PRIOR TO BIDDING AND/OR ORDERING MATERIALS.
13.

ALL PERMITS THAT MUST BE OBTAINED ARE THE RESPONSIBILITY OF THE CONTRACTOR. THE CONTRACTOR WILL BE RESPONSIBLE FOR ABIDING BY ALL CONDITIONS AND REQUIREMENTS OF THE PERMITS.
14.

24 HOURS PRIOR TO THE BEGINNING OF ANY CONSTRUCTION, THE CONTRACTOR MUST NOTIFY THE APPLICABLE JURISDICTIONAL (STATE, COUNTY OR CITY) ENGINEER.
15.

THE CONTRACTOR SHALL REWORK (DRY, SCARIFY, ETC.) ALL MATERIAL NOT SUITABLE FOR SUBGRADE IN ITS PRESENT STATE. AFTER REWORKING, IF THE MATERIAL REMAINS UNSUITABLE, THE CONTRACTOR SHALL UNDERCUT THIS MATERIAL AND REPLACE WITH APPROVED MATERIAL. ALL SUBGRADES SHALL BE PROOFROLLED WITH A FULLY LOADED TANDEM AXLE DUMP TRUCK PRIOR TO PAVING. ANY SOFTER MATERIAL SHALL BE REWORKED OR REPLACED.
16.

THE CONTRACTOR IS REQUIRED TO MAINTAIN ALL PIPES, DITCHES, AND OTHER DRAINAGE STRUCTURES FREE FROM OBSTRUCTION UNTIL WORK IS ACCEPTED BY THE OWNER. THE CONTRACTOR IS RESPONSIBLE FOR ANY DAMAGES CAUSED BY FAILURE TO MAINTAIN DRAINAGE STRUCTURE IN OPERABLE CONDITION.
17.

ALL MATERIALS AND WORKMANSHIP SHALL BE WARRANTED FOR ONE YEAR FROM ACCEPTANCE DATE.
18.

THE OWNER SHALL HAVE A SET OF APPROVED PLANS AVAILABLE AT THE SITE AT ALL TIMES WHILE WORK IS BEING PERFORED. A DESIGNATED RESPONSIBLE EMPLOYEE SHALL BE RESPONSIBLE FOR CONTACT BY GOVERNING AGENCY INSPECTORS.

STRUCTURAL STEEL NOTES:

1.

THE FABRICATION AND ERECTION OF STRUCTURAL STEEL SHALL CONFORM TO THE AISC SPECIFICATIONS AND MANUAL OF STEEL CONSTRUCTION, 13TH EDITION.
2.

UNLESS OTHERWISE NOTED, ALL STRUCTURAL ELEMENTS SHALL CONFORM TO THE FOLLOWING REQUIREMENTS:

A.

STRUCTURAL STEEL, ASTM DESIGNATION A36 OR A992 GR50.

B.

ALL BOLTS, ASTM A325 TYPE I GALVANIZED HIGH STRENGTH BOLTS.

C.

ALL NUTS, ASTM A563 CARBON AND ALLOY STEEL NUTS.

D.

ALL WASHERS, ASTM F436 HARDENED STEEL WASHERS.
3.

ALL CONNECTIONS NOT FULLY DETAILED ON THESE PLANS SHALL BE DETAILED BY THE STEEL FABRICATOR IN ACCORDANCE WITH AISC SPECIFICATIONS AND MANUAL OF STEEL CONSTRUCTION, 13TH EDITION.
4.

HOLES SHALL NOT BE FLAME CUT THRU STEEL UNLESS APPROVED BY THE ENGINEER.
5.

HOT-DIP GALVANIZE ALL ITEMS UNLESS OTHERWISE NOTED, AFTER FABRICATION WHERE PRACTICABLE. GALVANIZING: ASTM A123, ASTM A153/A153M OR ASTM A653/A653M, G90, AS APPLICABLE.
6.

REPAIR DAMAGED SURFACES WITH GALVANIZING REPAIR METHOD AND PAINT CONFORMING TO ASTM A780 OR BY APPLICATION OF STICK OR THICK PASTE MATERIAL SPECIFICALLY DESIGNED FOR REPAIR OF GALVANIZING. CLEAN AREAS TO BE REPAIRED AND REMOVE SLAG FROM WELDS. HEAT SURFACES TO WHICH STICK OR PASTE MATERIAL IS APPLIED, WITH A TORCH TO A TEMPERATURE SUFFICIENT TO MELT THE METALLICS IN STICK OR PASTED; SPREAD MOLTEN MATERIAL UNIFORMLY OVER SURFACES TO BE COATED AND WIPE OFF EXCESS MATERIAL.
7.

A NUT LOCKING DEVICE SHALL BE INSTALLED ON ALL PROPOSED AND/OR REPLACED BOLTS.
8.

ALL PROPOSED AND/OR REPLACED BOLTS SHALL BE OF SUFFICIENT LENGTH TO EXCLUDE THE THREADS FROM THE SHEAR PLANE.
9.

ALL PROPOSED AND/OR REPLACED BOLTS SHALL BE OF SUFFICIENT LENGTH SUCH THAT THE END OF THE BOLT BE AT LEAST FLUSH WITH THE FACE OF THE NUT. IT IS NOT PERMITTED FOR THE BOLT END TO BE BELOW THE FACE OF THE NUT AFTER TIGHTENING IS COMPLETED.
10.

ALL ASSEMBLY BOLTS ARE TO BE TIGHTENED TO A "SNUG TIGHT" CONDITION AS DEFINED IN SECTION 8.1 OF THE AISC, "SPECIFICATION FOR STRUCTURAL JOINTS USING ASTM A325 OR A490 BOLTS", DATED JUNE 30, 2004.
11.

FLAT WASHERS ARE TO BE INSTALLED WITH BOLTS OVER SLOTTED HOLES.
12.

DO NOT OVER TORQUE ASSEMBLY BOLTS. GALVANIZING ON BOLTS, NUTS, AND STEEL PARTS ;MAY ACT AS A LUBRICANT, THUS OVER TIGHTENING MAY OCCUR AND MAY CAUSE BOLTS TO CRACK AND SNAP OFF.
13.

PAL NUTS ARE TO BE INSTALLED AFTER NUTS ARE TIGHT AND WITH EDGE LIP OUT. PAL NUTS ARE NOT REQUIRED WHEN SELF-LOCKING NUTS ARE PROVIDED.
14.

GALVANIZED ASTM A325 BOLTS SHALL NOT BE REUSED.
15.

WELDING SHALL BE PERFORMED IN ACCORDANCE WITH AMERICAN WELDING SOCIETY (AWS) D1.1-2010 STRUCTURAL WELDING CODE – STEEL.

PLANS PREPARED FOR:



333 INVERNESS DRIVE SOUTH
ENGLEWOOD, CO 80112
OFFICE: (408) 560-1040


PROJECT INFORMATION:

CARSON

SITE #: DN90XCD31


5001 S PARKER RD
AURORA CO, 80015
(ARAPAHOE COUNTY)

PLANS PREPARED BY:

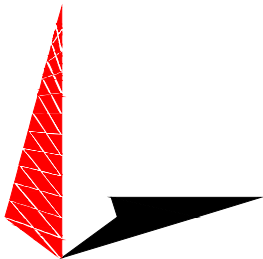

TOWER ENGINEERING PROFESSIONALS
500 E. 84TH AVE SUITE C10
THORNTON, CO 80229
OFFICE: (303) 566-9914
www.tepgroup.net

SEAL:

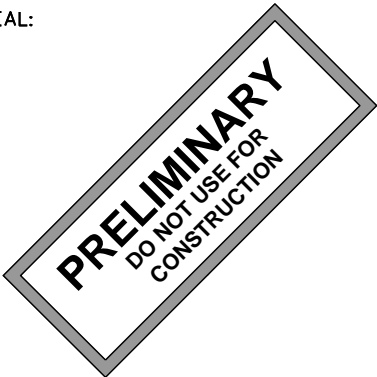

























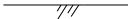


0	07-24-18	ZONING
REV	DATE	ISSUED FOR:

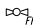DRAWN BY: AJL | CHECKED BY: ARB

SHEET TITLE:

GENERAL
NOTES

SHEET NUMBER:	REVISION:
N-1	0
	TEP #134006.202215

<h1>LEGEND</h1>	
	EXIST. PROPERTY LINE
	ADJ. PROPERTY LINE
	PROPERTY CORNER
	EXIST. UTILITY POLE
	TELCO PEDESTAL
	RIGHT-OF-WAY
	OVERHEAD WIRE
	UNDERGROUND WIRE
	UNDERGROUND GAS
	UNDERGROUND FIBER
	UNDERGROUND TELCO
	WATER PIPE
	EDGE OF PAVEMENT
	6'-TALL WOOD FENCE
	LEASE AREA/EASMENT CORNER
	TRANSFORMER
	LIGHT POLE
	FIRE HYDRANT
    	MAN HOLE (FIBER, SANITARY, STORM, TELCO, WATER)
 <i>GV</i>	GAS VALVE
 <i>GM</i>	GAS METER
 <i>WV</i>	WATER VALVE
 <i>WM</i>	WATER METER

SITE COORDINATES	
LATITUDE:	N 39° 36' 28.96" (NAD '83)
LONGITUDE:	W 104° 44' 32.87" (NAD '83)
ROOF ELEVATION:	5964.49' (NAVD '88)

ZONING:
RESIDENTIAL

EAST GRAND AVE
(R/W VARIES) PR
- CU

PROPOSED 10'-0"x10'-0"
CUPOLA. SEE DETAILS ON
SHEET Z-4.

PROPOSED 12'-0" ACCESS
EASEMENT _____

PROPOSED 10'-0"x11'-0"
LEASE AREA. SEE DETAILS
ON SHEET Z-2.

PROPOSED 3'-0" UTILITY
EASEMENT. SEE DETAILS
ON SHEET Z-2.

ZONING:
RESIDENTIAL

**ZONING:
RESIDENTIAL**

**ZONING:
RESIDENTIAL**

ZONING:
RESIDENTIAL

SOUTH CARSON C
(R/N VARIES)

N/F
ABBA REAL ESTATE INC
1130 LAKE PLAZA DR
COLORADO SPRINGS, CO 80906
PID:
2073-07-3-02-045

EXISTING 16'-0" WIDE
UTILITY EASEMENT

EXISTING 16'-0" WIDE
UTILITY EASEMENT

**PARKER ROAD COLORADO
STATE HWY 83
(R/W VARIES)**

— PROPOSED 11'-0" LONG
SHROUDED ANTENNA MOUNT.
SEE DETAILS ON SHEET Z-4.

— EXISTING 23'-0" WIDE
FIRELANE EASEMENT

EXISTING 12'-0" WIDE
UTILITY EASEMENT

N/F
CWC INCOME
PROPERTIES 5 LLC
5001 S PARKER RD,
AURORA, CO 80015
PID:
2073-23-1-13-006

PROPOSED 10'-0"x10'-0"
CUPOLA. SEE DETAILS ON
SHEET Z-4.


EXISTING 16'-0" WIDE
UTILITY EASEMENT

— EXISTING 26'-0" WIDE
UTILITY EASEMENT

— EXISTING 5'-0" WIDE
SIDEWALK EASEMENT

1. THE BASIS OF THE MERIDIANS AND COORDINATES FOR THIS PLAT IS THE COLORADO STATE PLANE COORDINATE SYSTEM, NORTH AMERICAN DATUM 1983 (NAD83).
2. VERTICAL INFORMATION SHOWN, BASED ON THE NORTH AMERICAN VERTICAL DATUM OF 1988 (NAVD 88).
3. ALL DISTANCES ARE GROUND UNLESS OTHERWISE NOTED.
4. THE TOWER IS LOCATED IN AN AREA DESIGNATED AS ZONE X, AREAS OUTSIDE OF 0.2% ANNUAL FLOOD CHANCE (FEMA MAP # 08005C2091F).


SCALE: 1" = 30'

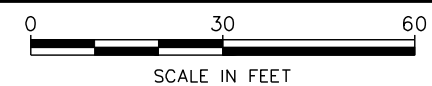

PROJECT INFORMATION:

SITE #: DN90XCD31

PLANS PREPARED BY:

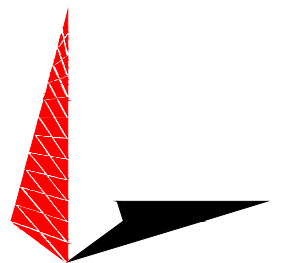

SEAL:

PRELIMINARY
DO NOT USE FOR
CONSTRUCTION

0	07-24-18	ZONING
REV	DATE	ISSUED FOR:

DRAWN BY: BRC	CHECKED BY: ARB
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SHEET TITLE:

SITE PLAN


SHEET NUMBER:

Z-1

REVISION:

0

EP #:134006.202215

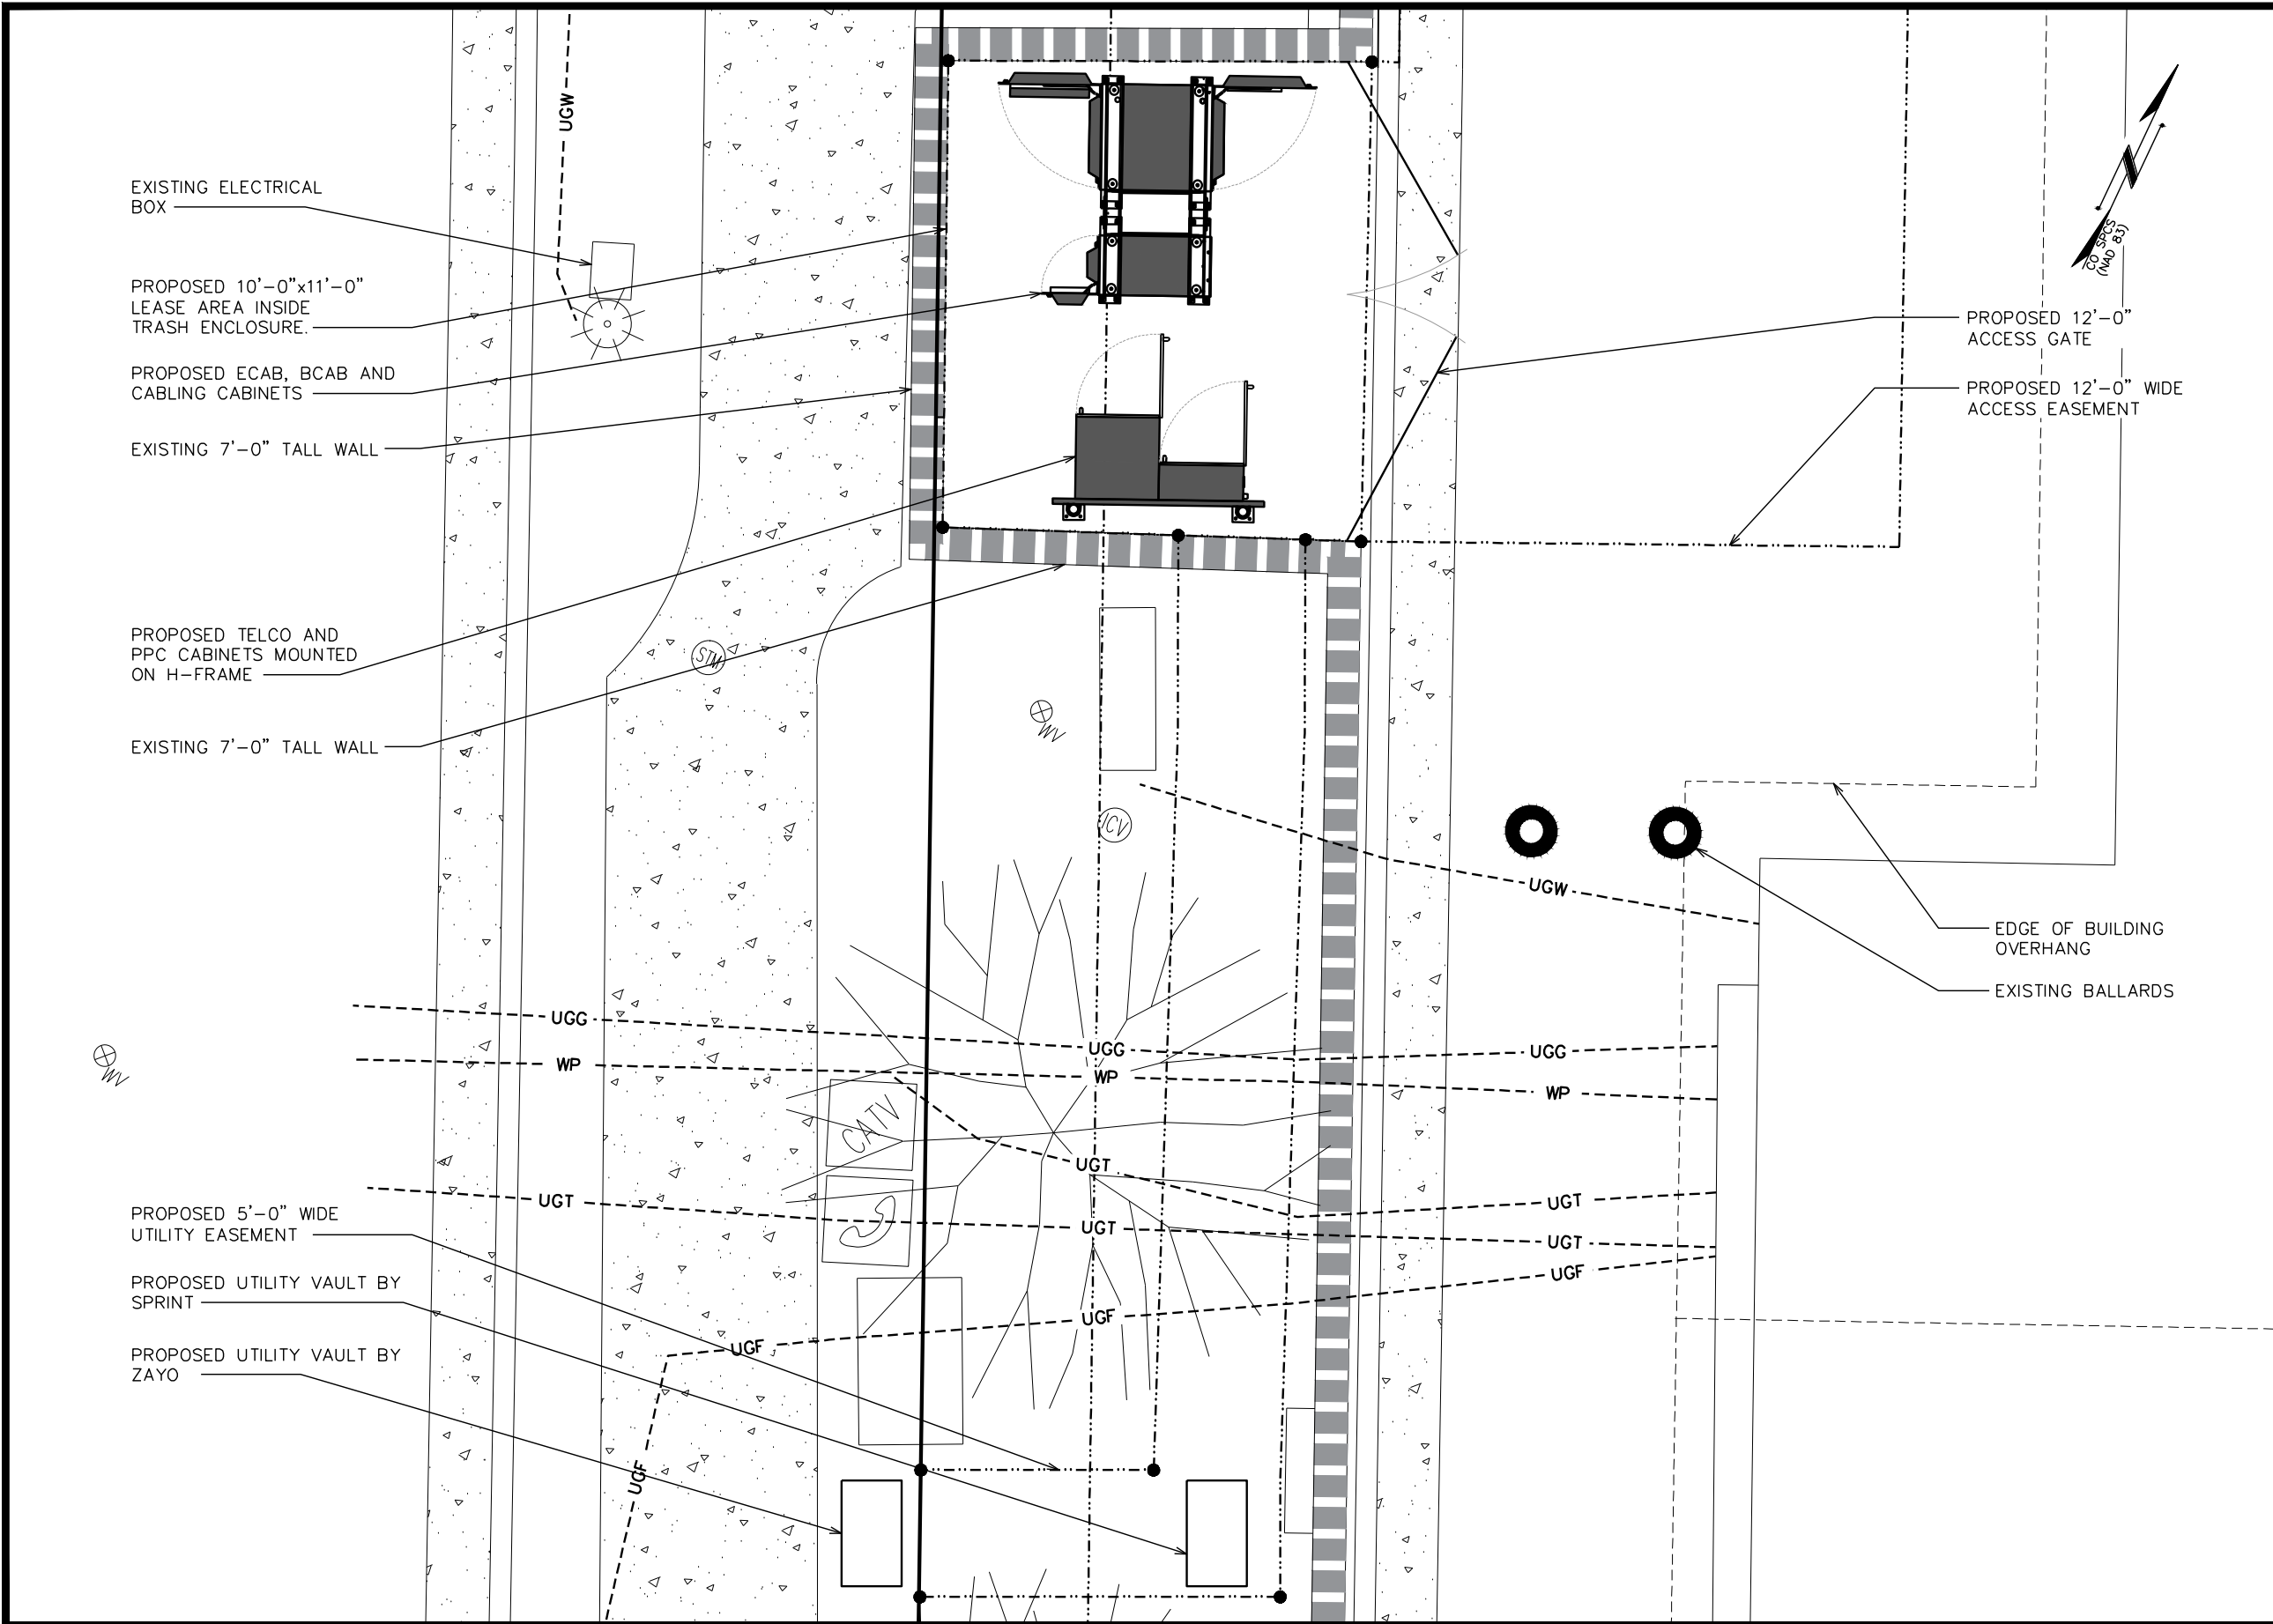

PLANS PREPARED FOR:

333 INVERNESS DRIVE SOUTH
ENGLEWOOD, CO 80112
OFFICE: (408) 560-1040

PROJECT INFORMATION:

CARSON

SITE #: DN90XCD31
5001 S PARKER RD
AURORA CO, 80015
(ARAPAHOE COUNTY)

PLANS PREPARED BY:

TOWER ENGINEERING PROFESSIONALS
500 E. 84TH AVE SUITE C10
THORNTON, CO 80229
OFFICE: (303) 566-9914
www.tepgroup.net

SEAL:

PRELIMINARY
DO NOT USE FOR
CONSTRUCTION

0	07-24-18	ZONING
REV	DATE	ISSUED FOR:

DRAWN BY:	BRC	CHECKED BY:	ARB
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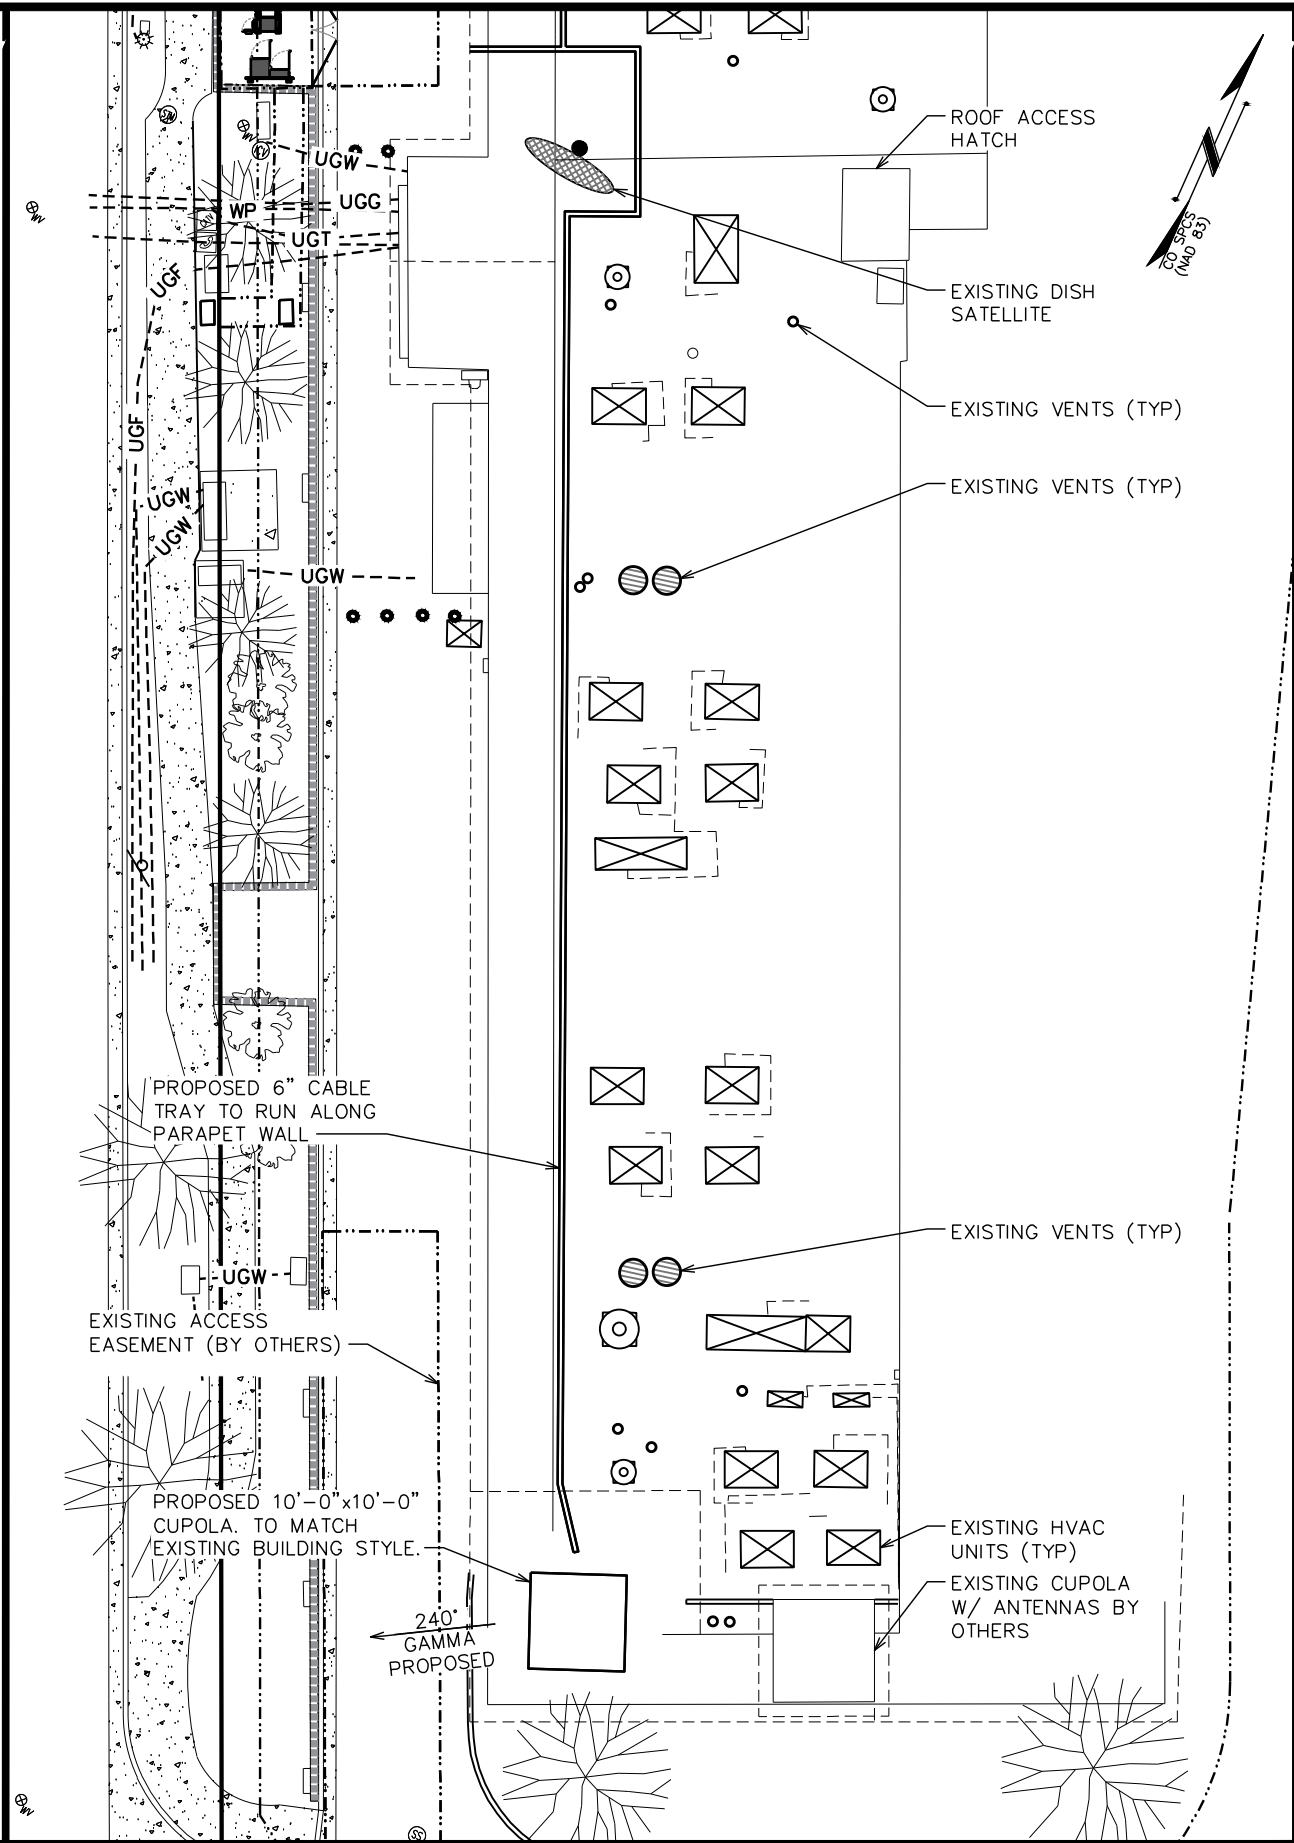
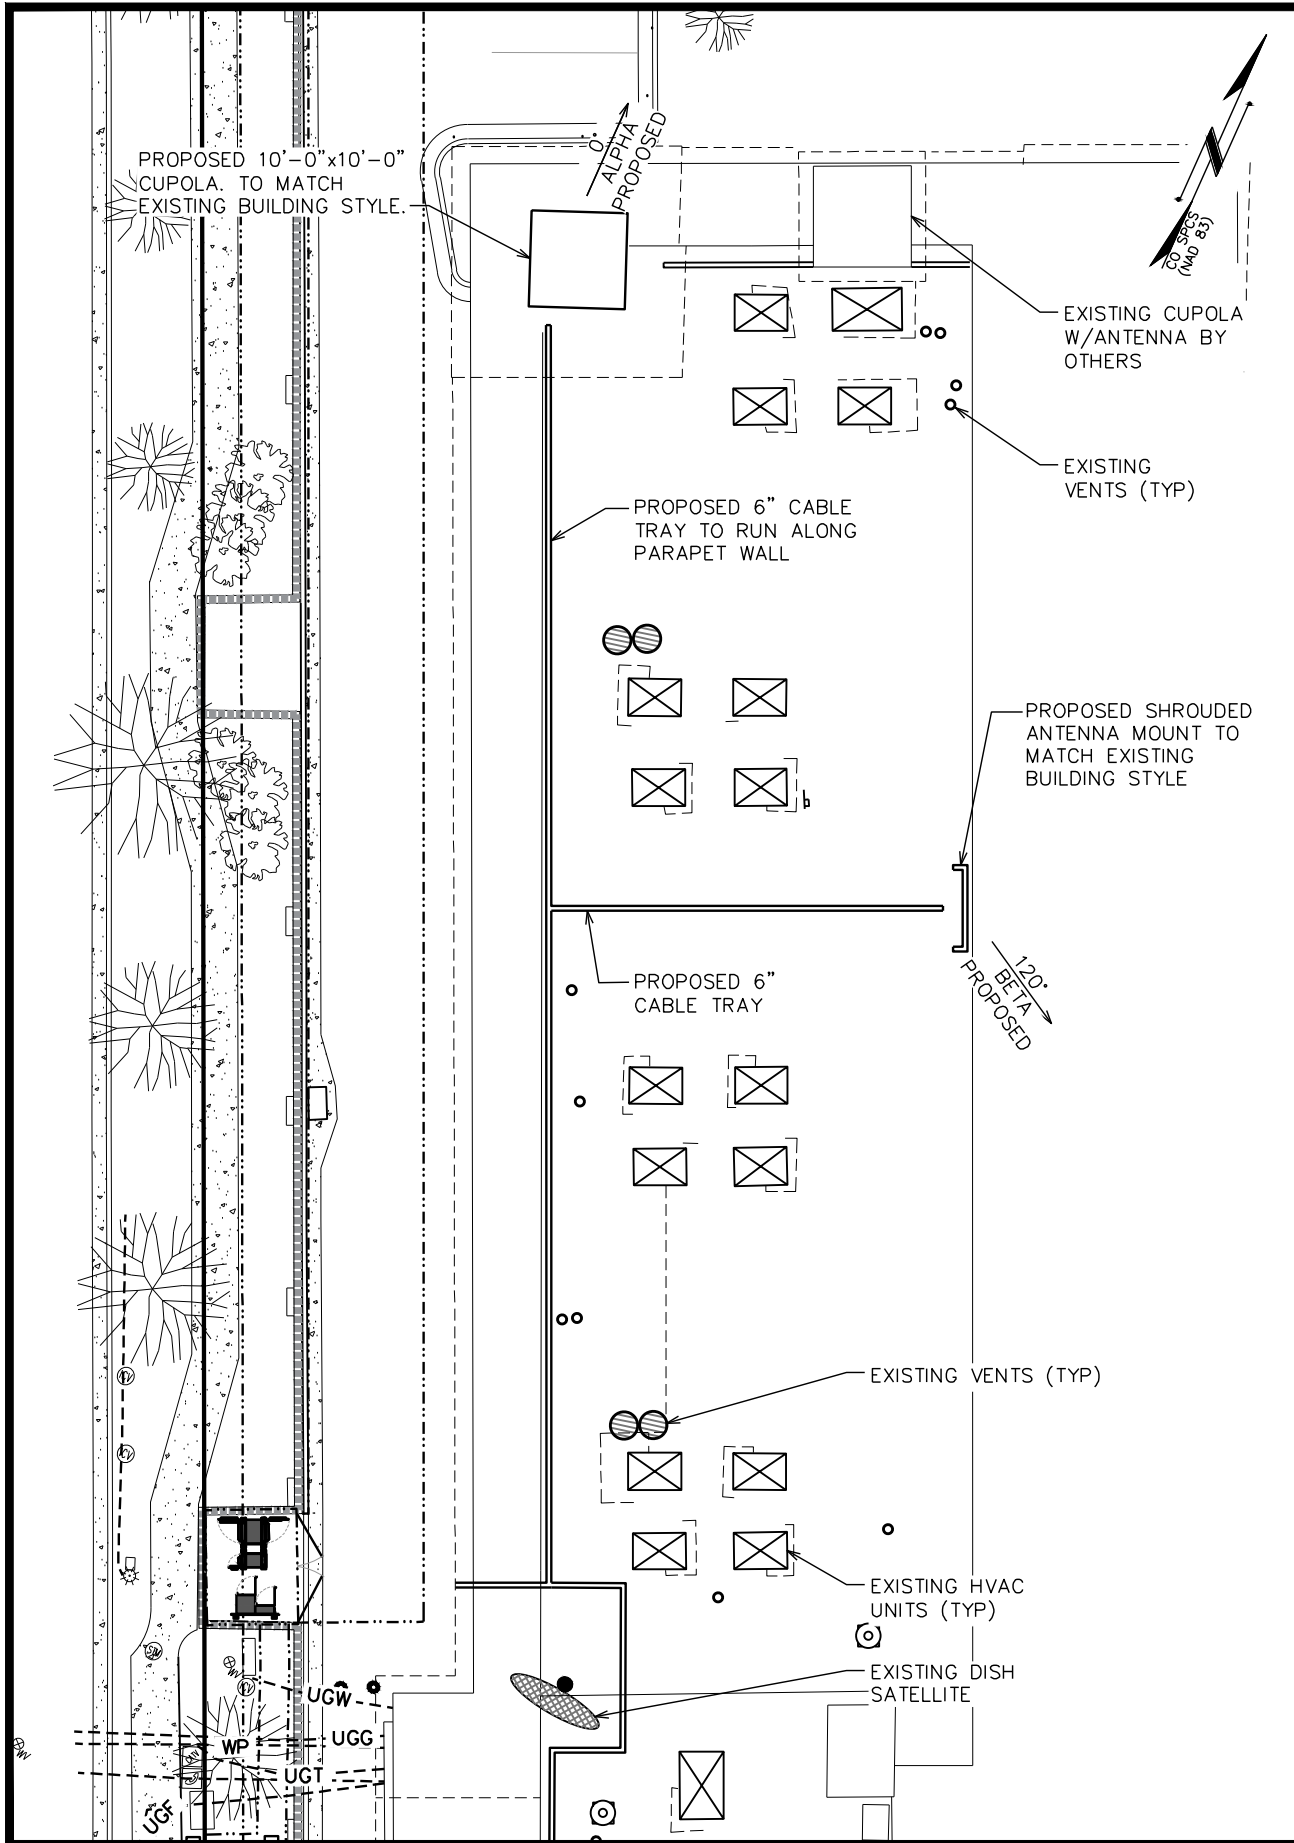
SHEET TITLE:

COMPOUND DETAIL

SHEET NUMBER: Z-2	REVISION: 0 TEP #134006.202215
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COMPOUND PLAN

SCALE: 3/8" = 1'-0"



ROOF PLAN (NORTH END)

SCALE: 1" = 20'-0"

ROOF PLAN (SOUTH END)

SCALE: 1" = 20'-0"

PLANS PREPARED FOR:



333 INVERNESS DRIVE SOUTH
ENGLEWOOD, CO 80112
OFFICE: (408) 560-1040


PROJECT INFORMATION:

CARSON

SITE #: DN90XCD31


5001 S PARKER RD
AURORA CO, 80015
(ARAPAHOE COUNTY)

PLANS PREPARED BY:

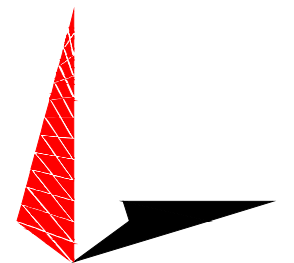

TOWER ENGINEERING PROFESSIONALS
500 E. 84TH AVE SUITE C10
THORNTON, CO 80229
OFFICE: (303) 566-9914
www.tepgroup.net

SEAL:

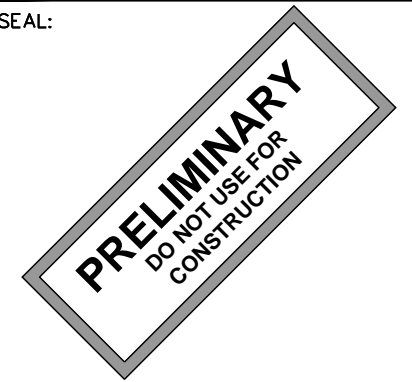


0	07-24-18	ZONING
REV	DATE	ISSUED FOR:

DRAWN BY: BRC CHECKED BY: ARB

SHEET TITLE:


ROOF PLAN

SHEET NUMBER:	REVISION:
Z-3	0
TEP #134006.202215	

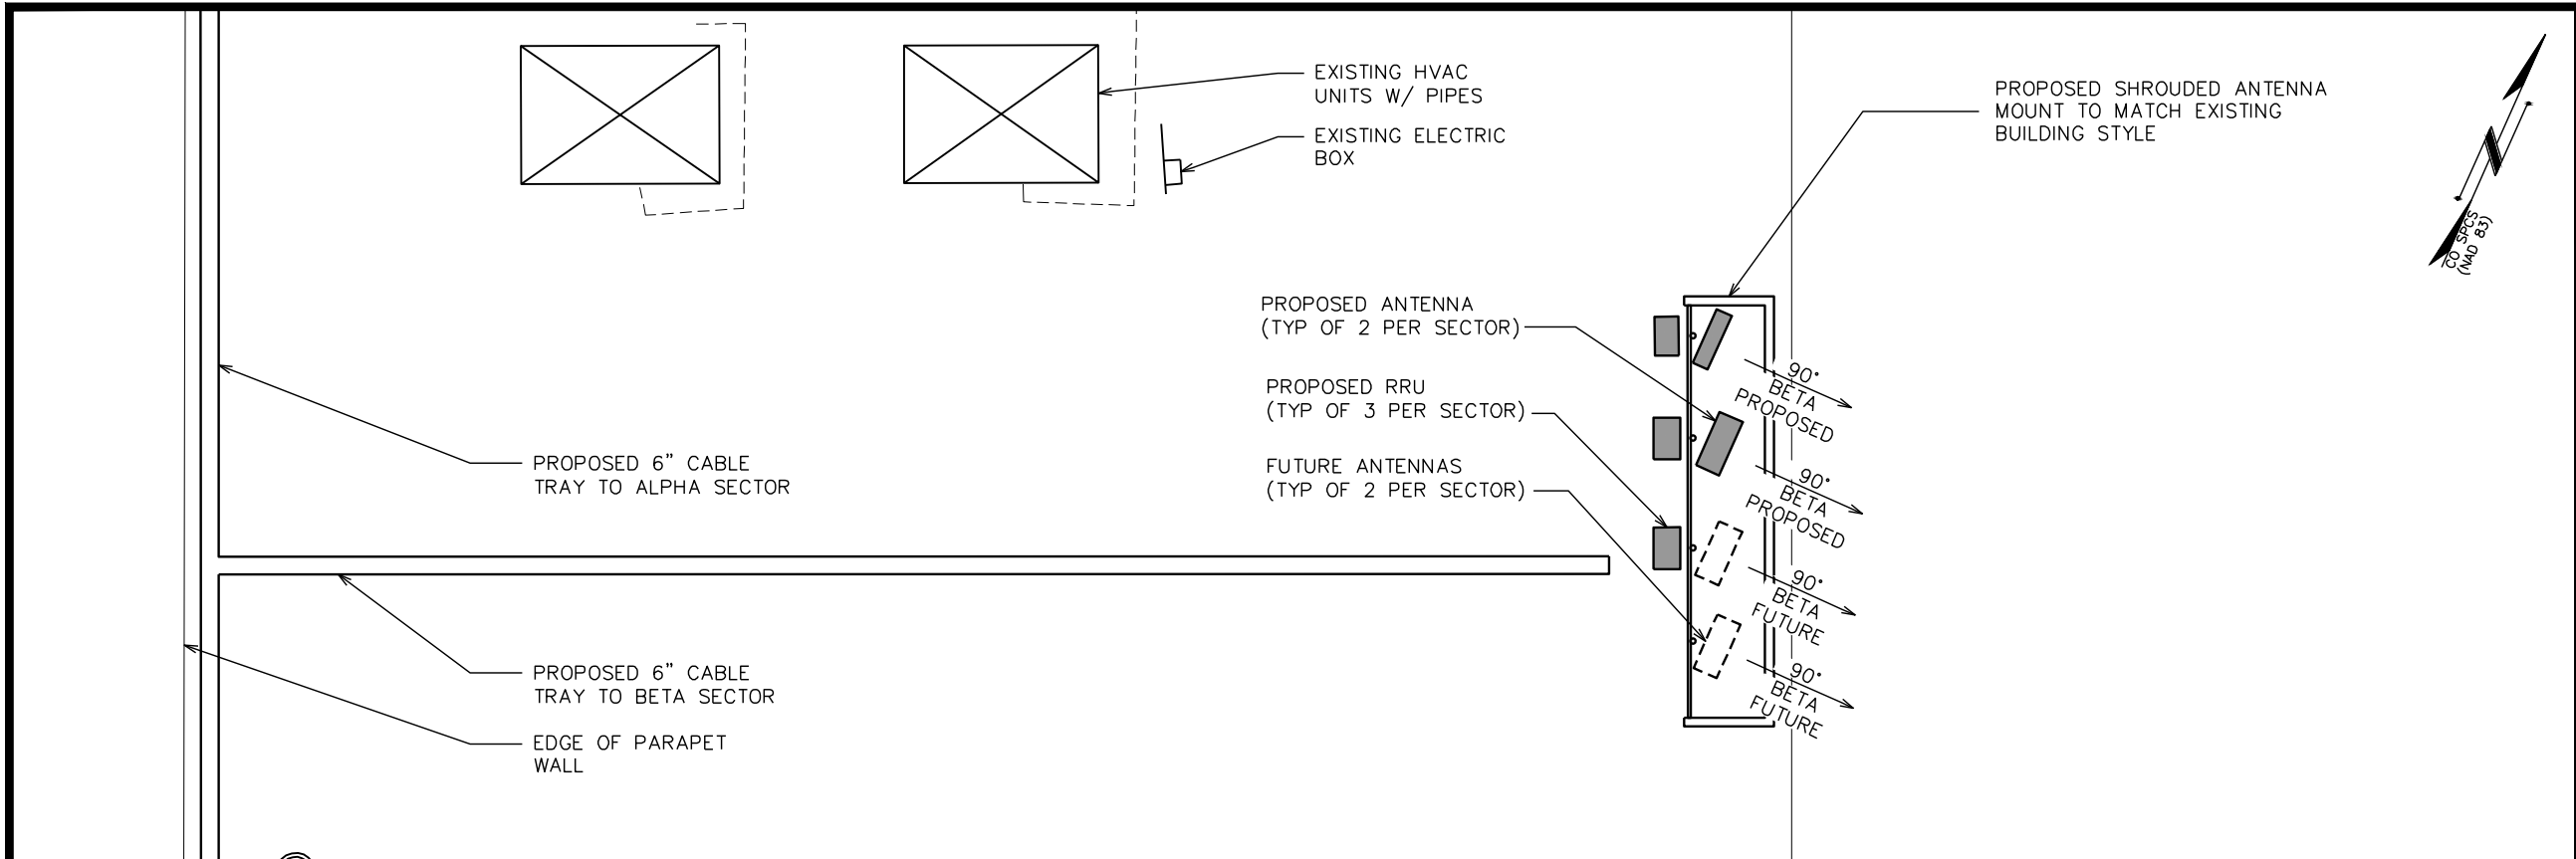


ANTENNA MOUNTING DETAILS (BETA SECTOR)

SCALE: 3/16" = 1'-0"

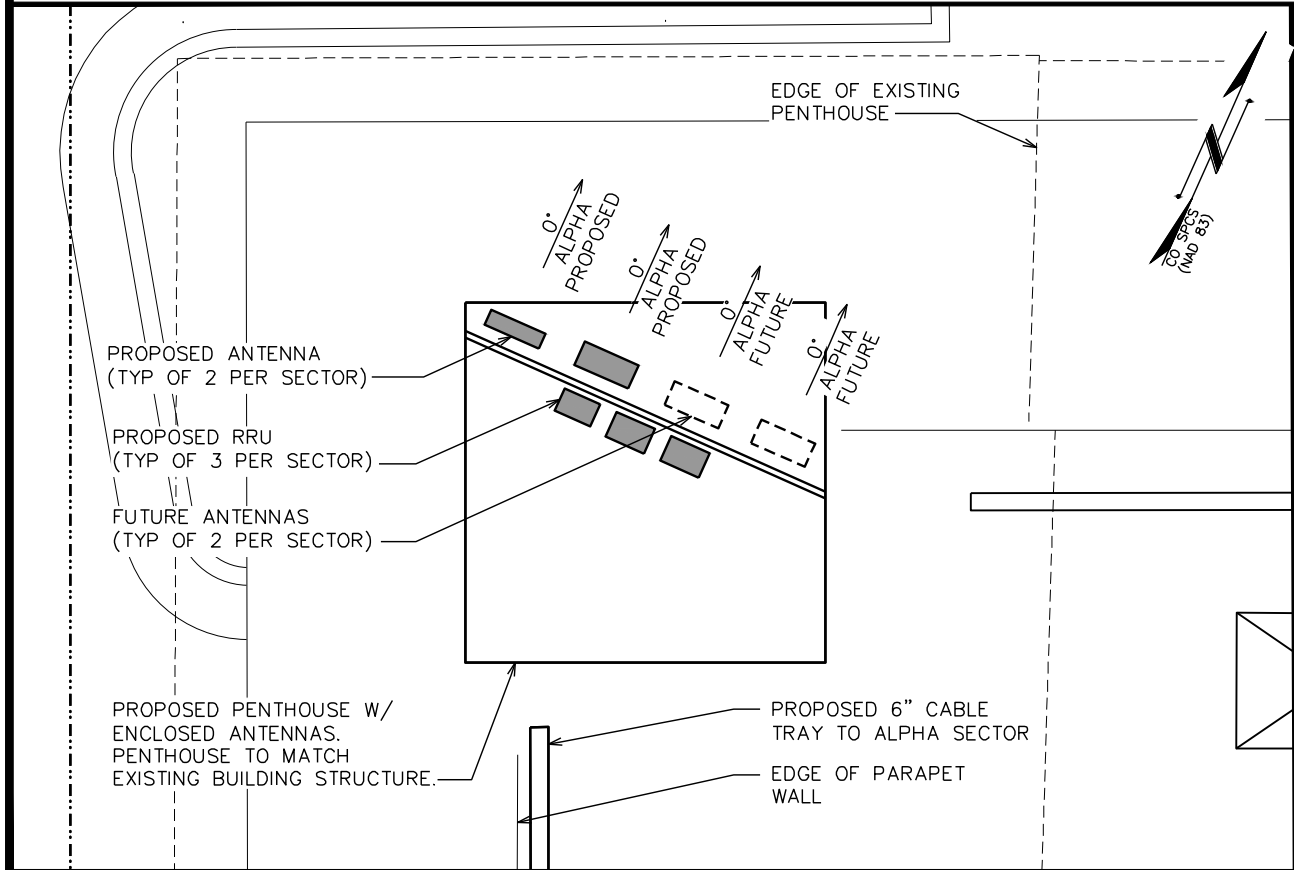

ANTENNA MOUNTING DETAILS (ALPHA SECTOR)

SCALE: 3/16" = 1'-0"

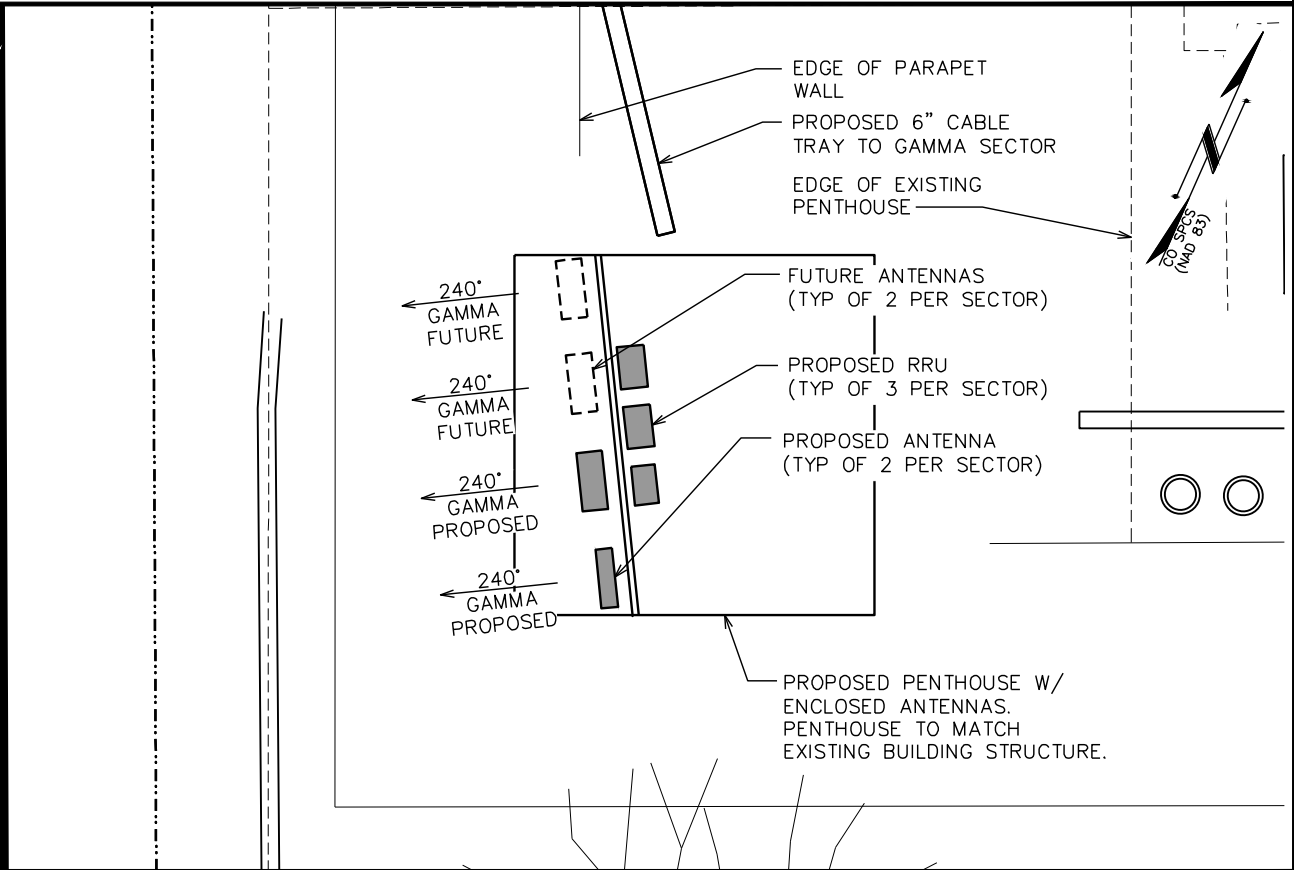

ANTENNA MOUNTING DETAILS (GAMMA SECTOR)

SCALE: 3/16" = 1'-0"

PLANS PREPARED FOR:



333 INVERNESS DRIVE SOUTH
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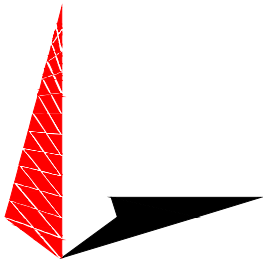
PROJECT INFORMATION:

CARSON

SITE #: DN90XCD31


5001 S PARKER RD
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(ARAPAHOE COUNTY)

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SEAL:



0	07-24-18	ZONING
REV	DATE	ISSUED FOR:

DRAWN BY: BRC CHECKED BY: ARB

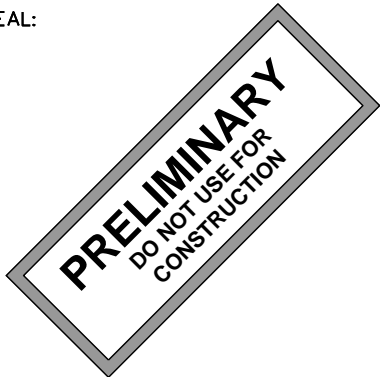SHEET TITLE:

**ANTENNA
MOUNTING DETAILS**


SHEET NUMBER:

Z-4

REVISION:



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TEP #134006.202215

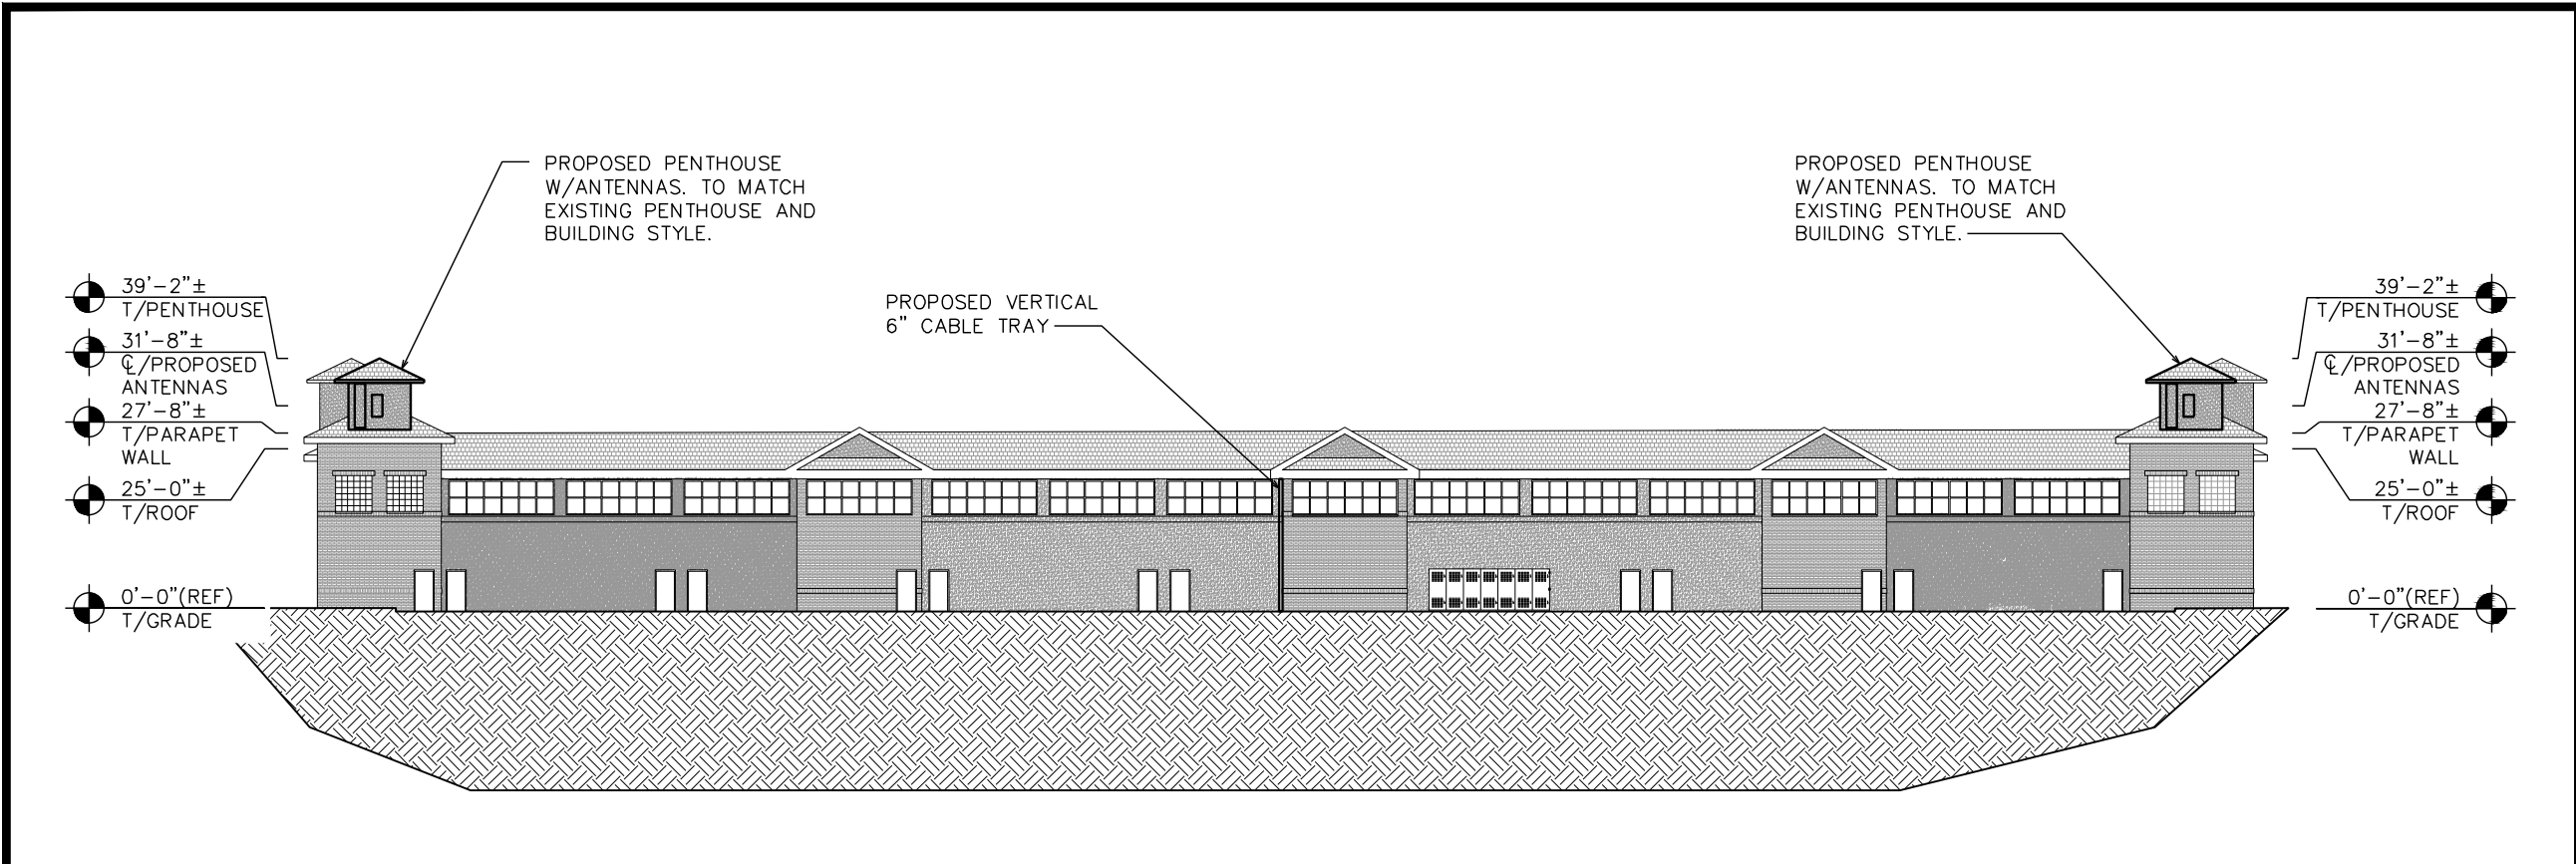


WEST ELEVATION (LOOKING EAST)

SCALE: 1" = 30'-0"

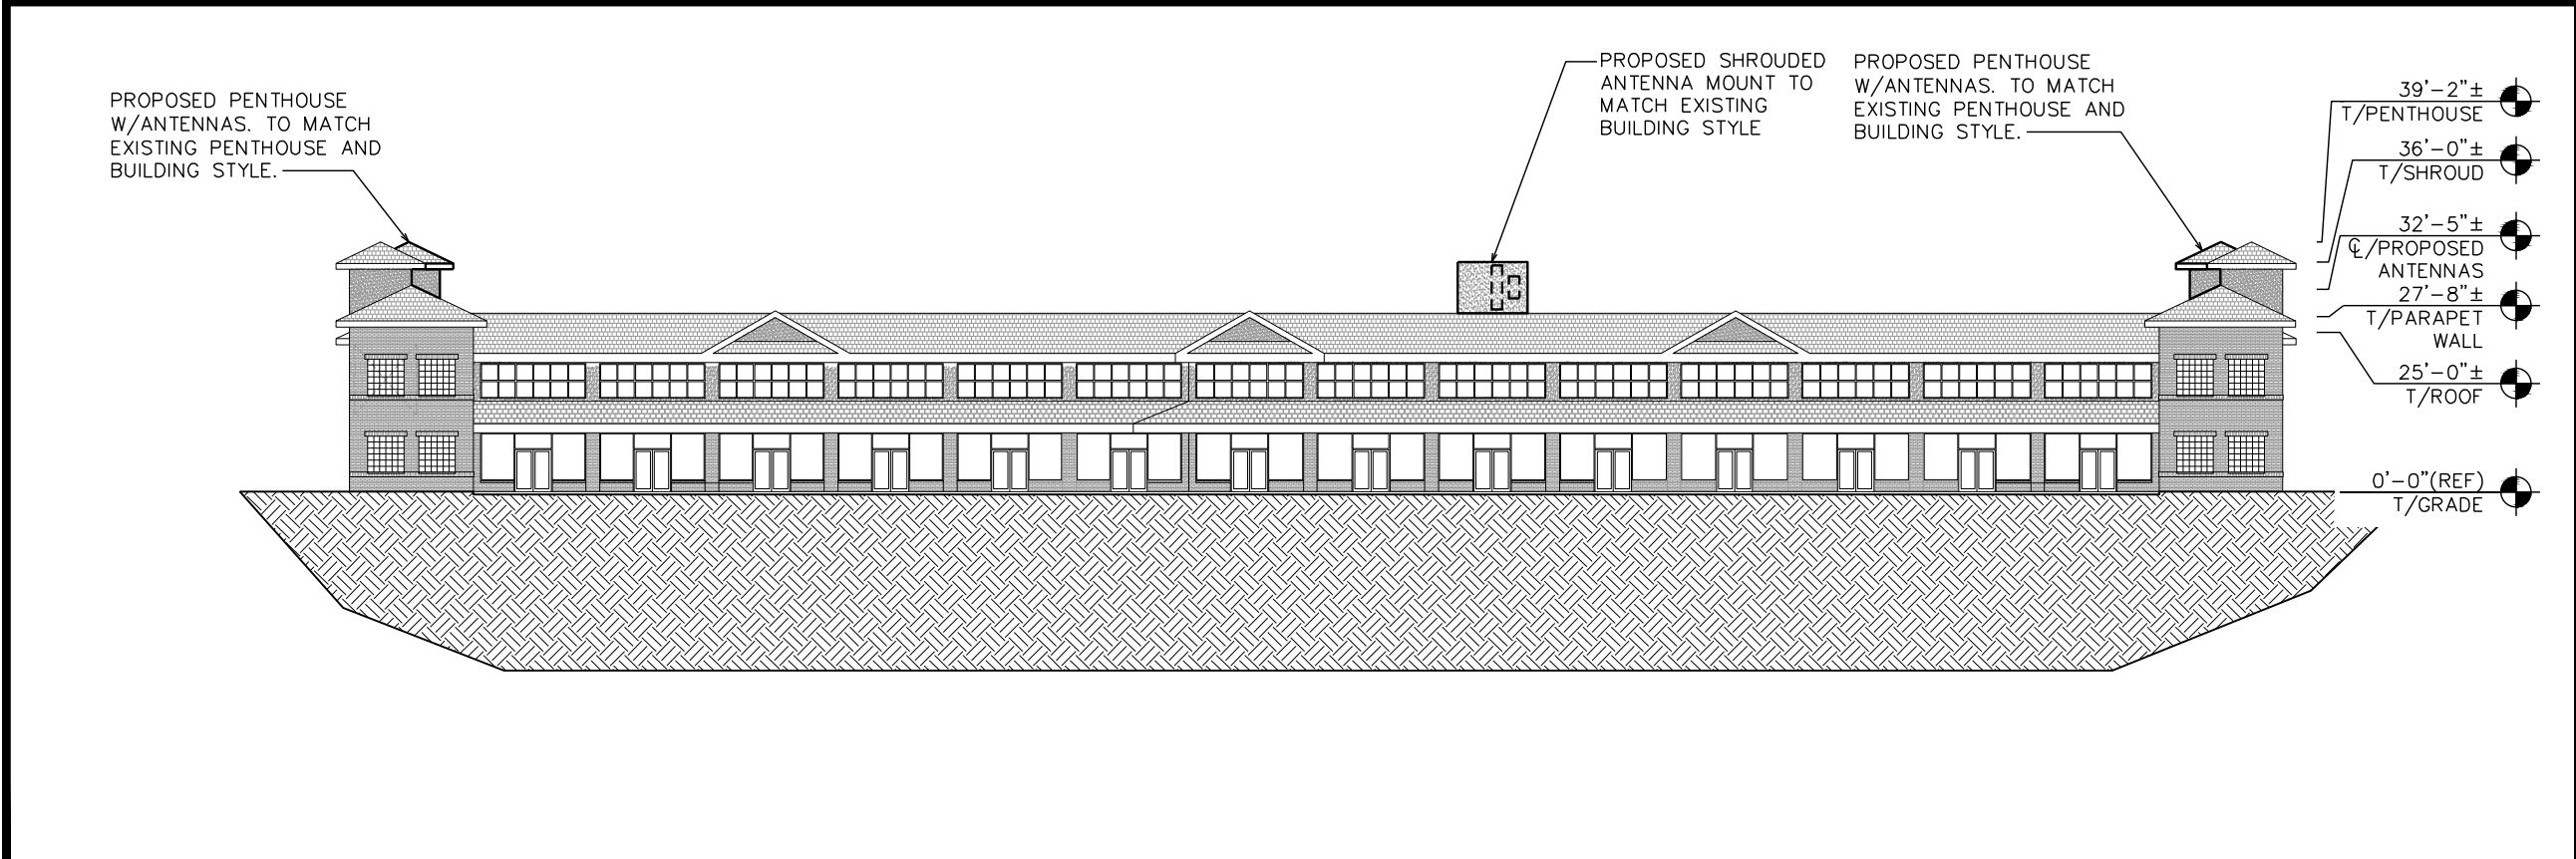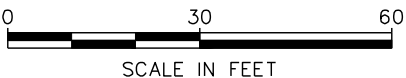

EAST ELEVATION (LOOKING WEST)

SCALE: 1" = 30'-0"

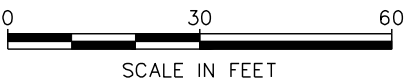

PLANS PREPARED FOR:



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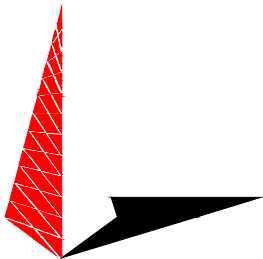
PROJECT INFORMATION:

CARSON

SITE #: DN90XCD31


5001 S PARKER RD
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SEAL:




0	07-24-18	ZONING
REV	DATE	ISSUED FOR:

DRAWN BY: BRC CHECKED BY: ARB

SHEET TITLE:

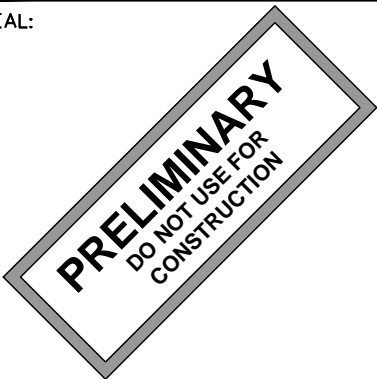BUILDING ELEVATION I

SHEET NUMBER:	REVISION:
Z-5	0
TEP #134006.202215	

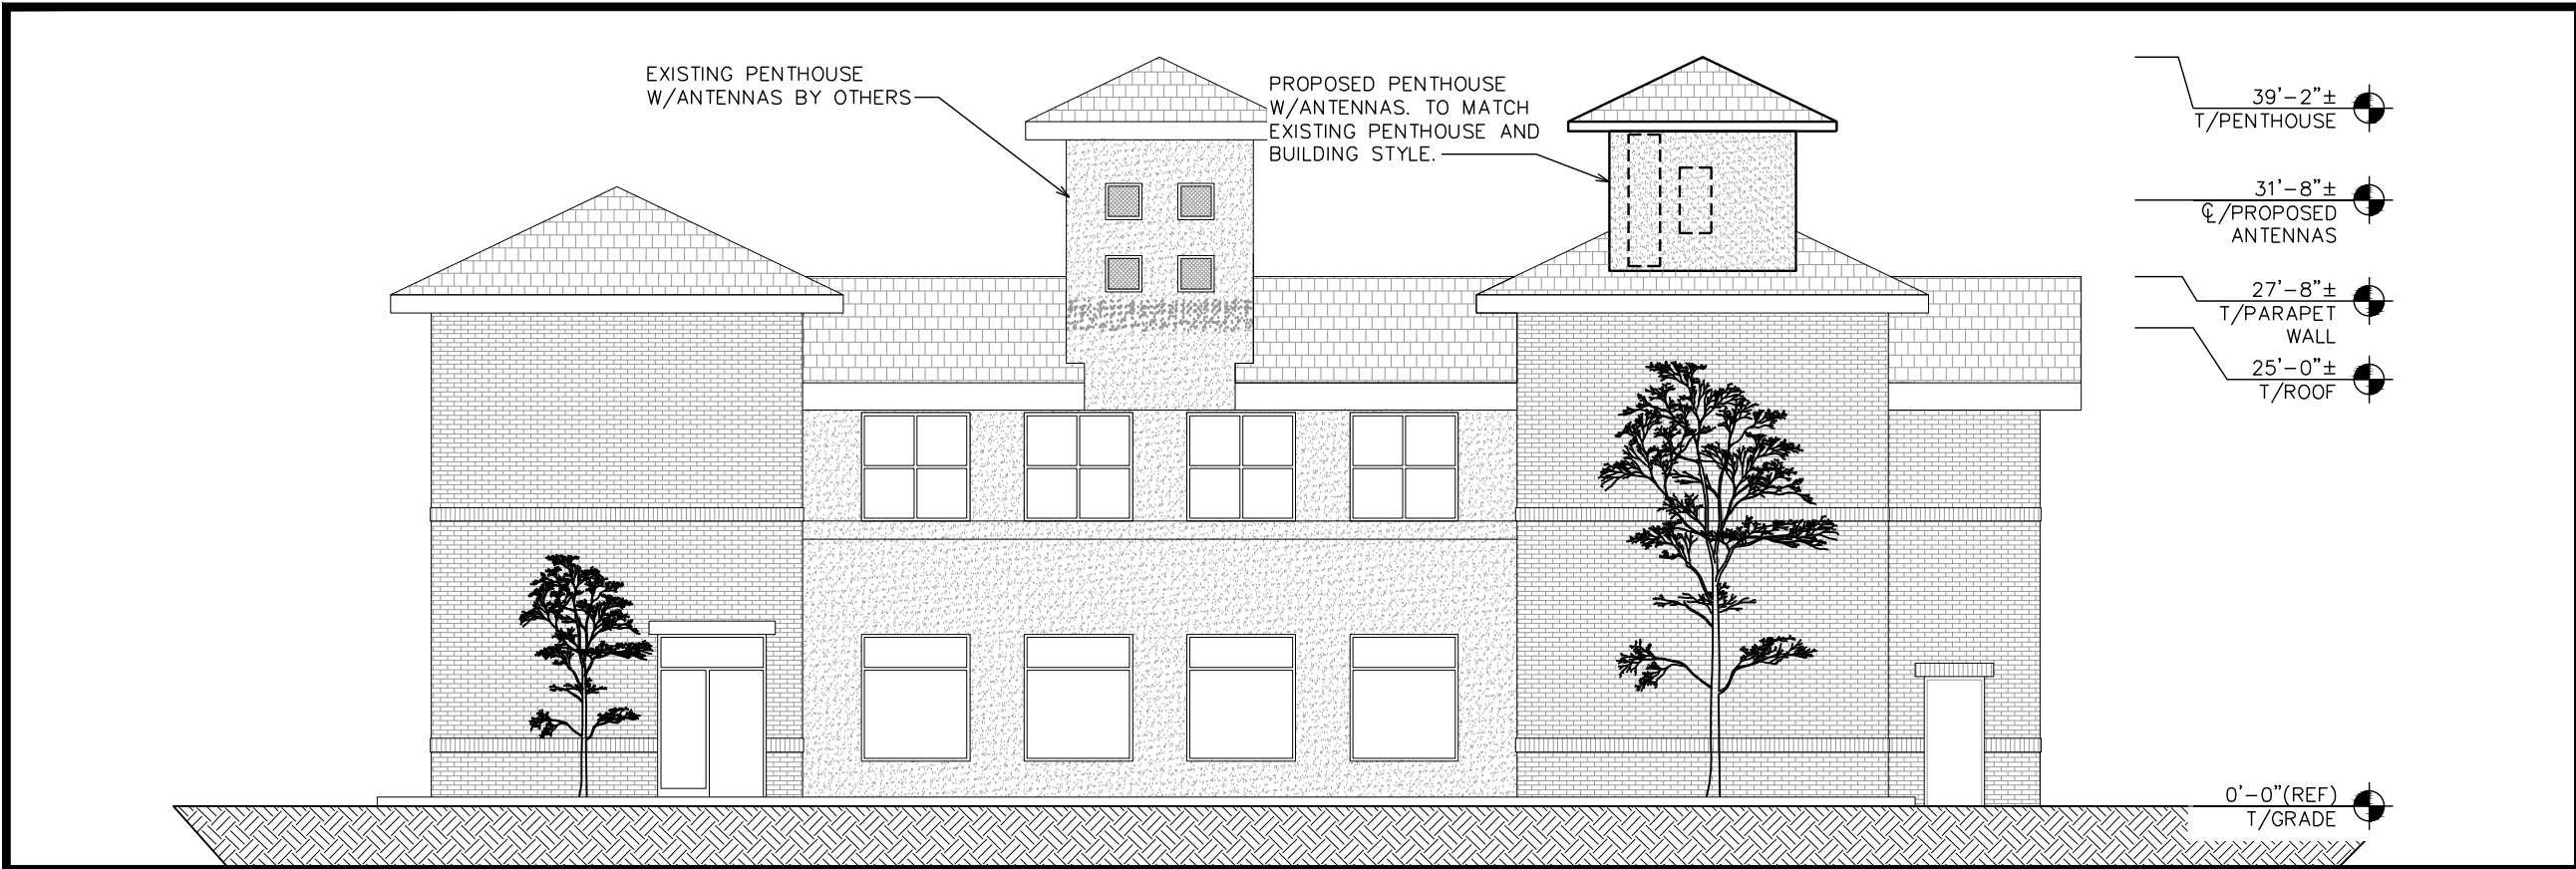

NORTH ELEVATION (LOOKING SOUTH)

SCALE: 1" = 10'-0"



SOUTH ELEVATION (LOOKING NORTH)

SCALE: 1" = 10'-0"

PLANS PREPARED FOR:



333 INVERNESS DRIVE SOUTH
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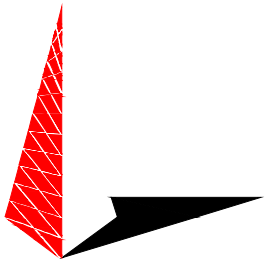
PROJECT INFORMATION:

CARSON

SITE #: DN90XCD31


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PLANS PREPARED BY:



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SEAL:



0	07-24-18	ZONING
REV	DATE	ISSUED FOR:

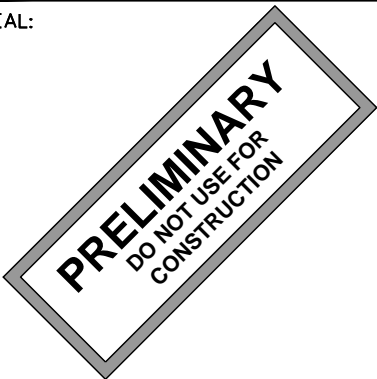DRAWN BY: BRC CHECKED BY: ARB

SHEET TITLE:

**BUILDING
ELEVATIONS II**

SHEET NUMBER:	REVISION:
Z-6	0
	TEP #134006.202215