

Will Prescott

2953 S Peoria St., #101

Phone: 303.770.7201 Fax: 303.770.7132

## LEGEND

— EXISTING MAJOR CONTOUR— EXISTING MINOR CONTOUR

EX. DECIDUOUS TREE TO REMAIN


EX. DECIDUOUS TREE
TO BE REMOVED

EXISTING TELECOM

EXISTING ELECTRIC

SS — EXISTING SAN. SEWER

EXISTING STORM

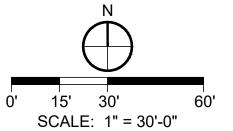



### TREE PRESERVATION NOTES:

- PRIOR TO THE BEGINNING OF CONSTRUCTION, ESTABLISH THE TREE PROTECTION ZONE (TPZ) BY INSTALLING TREE PROTECTION FENCING AROUND ALL EXISTING TREES TO REMAIN. LOCATE FENCING AT THE OUTSIDE OF THE DRIP LINE OF THE TREES OR AT A DISTANCE FROM THE TREE TRUNK OF ONE (1) FOOT OF RADIUS FOR EVERY INCH OF TRUNK DIAMETER, WHICHEVER IS GREATER. FOLLOWING INSTALLATION OF FENCING, REQUEST INSPECTION BY THE CITY OF AURORA PARKS & FORESTRY DIVISION (303-739-7177) OR AUTHORIZED DESIGNEE.
- TREE PROTECTION FENCING SHALL BE 4' HEIGHT, ORANGE MESH FENCING ATTACHED TO 'T' POSTS.
  FENCING SHALL BE INSPECTED AND MAINTAINED DAILY.
- 3. CONTRACTORS SHALL BE RESPONSIBLE FOR ALL OF THEIR WORKERS, SUBCONTRACTORS AND SUPPLIERS UNDER THIS REQUIREMENT. WITHIN THE TREE PROTECTION ZONE, THE FOLLOWING CONSTRUCTION ACTIVITIES SHALL NOT BE ALLOWED EXCEPT AS NECESSARY TO EXECUTE DETAILS TP-2.0 & 2.1
- 3.1. EQUIPMENT USE AND STORAGE
- 3.2. MATERIAL DELIVERY OR STORAGE
- 3.3. VEHICLE TRAFFIC, PARKING, USE, OR STORAGE
- 3.4. SPREADING, EXCAVATING, COMPACTING OR STOCKPILING OF SOIL
- 3.5. CONCRETE WASH-OUT AREAS AND RUN-OFF FROM CONCRETE WASH-OUT AREAS
- 3.6. FOOT TRAFFIC

AURORA, CO 80012

PHONE: (303) 739-7300

- 3.7. RUN-OFF CONTAINING HARMFUL LIQUIDS SUCH AS OIL, GAS, PAINT, SOLVENTS, FERTILIZER, ASPHALT, MORTAR, TAR, OR SIMILAR MATERIALS.
- 4. VIOLATION OF THE TREE PROTECTION ZONE SHALL RESULT IN A FINE OF \$500 PER INCIDENCE AND MAY BE INCREASED BASED ON THE PERCENTAGE OF THE ZONE AFFECTED MULTIPLIED BY THE FULL VALUE OF THE TREE (OR TREES) ESTABLISHED PRIOR TO CONSTRUCTION. IF MORE THAN 30% OF THE TPZ IS DAMAGED, THE FINE SHALL BE THE FULL VALUE OF THE ADJACENT TREE (OR TREES). FOR THE PURPOSE OF THESE REQUIREMENTS, CONSTRUCTION FENCING (LOCATED AT THE LIMITS OF CONSTRUCTION) SHALL BE TREATED AS TREE PROTECTION FENCING AND SHALL ESTABLISH A TPZ FOR NEARBY TREES.
- 5. DAMAGE TO THE MAIN TRUNKS OF TREES IS PROHIBITED. DAMAGE NOT PREVIOUSLY DOCUMENTED SHALL RESULT IN A FINE BASED ON THE PERCENTAGE OF THE CIRCUMFERENCE AFFECTED. DAMAGE GREATER THAN 30% OF THE CIRCUMFERENCE OR AFFECTING THE STRUCTURAL INTEGRITY OF THE TREE WILL RESULT IN A FINE EQUAL TO THE FULL VALUE OF THE TREE.
  - LIMB REMOVAL IS PROHIBITED, UNLESS APPROVED PRIOR TO CONSTRUCTION OR AS AUTHORIZED BY THE CITY OF AURORA PARKS & FORESTRY DIVISION. LIMB REMOVAL, IF APPROVED, SHALL BE DONE PRIOR TO THE START OF CONSTRUCTION. DAMAGED BRANCHES SHALL BE PRUNED WITHIN 10 DAYS OF THE OCCURENCE UTILIZING ANSI A300 STANDARDS. UNAUTHORIZED LIMB DAMAGE OR REMOVAL CAN RESULT IN A FINE OF \$500 PER BRANCH AS MAY BE DETERMINED BY THE CONSTRUCTION MANAGER OR HIS FORESTRY CONSULTANT. LIMB REMOVAL AND ALL OTHER APPROVED PRUNING SHALL BE PERFORMED BY A PROFESSIONAL COMPANY THAT IS LICENSED BY THE CITY OF AURORA FORESTRY DIVISION.
- . IF ROOTS GREATER THAN ONE (1) INCH DIAMETER REQUIRE CUTTING/REMOVAL, A CLEAN CUT SHALL BE ACCOMPLISHED BY A SHARP HAND TOOL. A MAXIMUM OF TWO (2) 3-INCH DIAMTER ROOTS PER TREE ARE PERMITTED FOR REMOVAL. THE REMOVAL OF ADDITIONAL ROOTS 3-INCHES OR GREATER IN DIAMETER REQUIRES APPROVAL OF THE CITY FORESTER OR AUTHORIZED DESIGNEE.
- 8. EXISTING TREES DAMAGED BY CONSTRUCTION ACTIVITIES SHALL BE IMMEDIATELY REPAIRED AND IF DAMAGED BEYOND REPAIR, REPLACED PER THE MITIGATION SPECIFICATIONS OUTLINED IN SECTION IV, SUBSECTION A, ITEM A OF THE TREE PRESERVATION POLICY. THE MITIGATION PLAN FOR THESE TREES SHALL FOLLOW THAT APPROVED THROUGH THE SITE PLAN SUBMITTAL.
- PER CITY OF AURORA POLICY ON PRESERVATION OF EXISTING TREES, AND DUE TO SITE CONSTRAINTS, DECIDUOUS TREES TAGGED FOR REMOVAL SHALL BE MITIGATED VIA PAYMENT OF VALUE OF CALIPER INCHES LOST TO THE TREE PLANTING FUND.

	Void:	Sheet Subset:	TREE MIT.	Subset Sheets:		TM-1 of 2	Sheet Number
		Detailer:	WJP	Numbers			
	Revised:	Designer:	WJP	Structure			CDOT Sub-Account No. 23594
	No Revisions:	TREE MITIGATION PLAN				Federal Aid No. STU-M055-056	
RKS	As Constructed	NINE MILE PEDESTRIAN BRIDGE SOUTH PLAZA (RTD SITE)				Project Number	


#### FORMULA FOR LIMIT OF DISTURBANCE:

ROOT ZONE DISTURBANCE SHALL NOT BE ALLOWED CLOSE TO THE TRUNK OF ANY TREE TO BE PRESERVED. MINIMUM DISTANCE BETWEEN THE TRUNK AND THE DISTURBANCE SHALL BE EQUAL TO 1/2 OF THE TREE'S DIAMETER CONVERTED TO FEET. (FOR EXAMPLE, FOR A TREE WITH A 15" DIAMETER TRUNK, THE DISTURBANCE CAN NOT BE CLOSER THAN 7.5 FEET FROM THE TRUNK.

#### REQUIRED TREATMENTS:

- 1. APPLY PREVENTATIVE SPRAY FOR MOUNTAIN PINE BEETLE (MPB) AND IPS TO PONDEROSA, AUSTRIAN & SCOTCH PINES. TREAT ALL BARK SURFACES, INCLUDING TOP BRANCHES. 2. IF DISTURBANCE LEAVES A CUT SLOPE,
- IMMEDIATELY APPLY MULCH AND WATER. IF DISTURBANCE IS A TRENCH, IMMEDIATELY BACKFILL AND WATER.
- 3. ONCE PER MONTH, EVALUATE TREE TO DETERMINE IF TREE IS LEANING OR IF BRANCHES / LEAVES ARE AFFECTED BY ROOT LOSS.
- 4. DO NOT FERTILIZE.
- 5. INSPECT TREE 2-3 TIMES PER YEAR FOR WATER NEEDS AND MONITOR FOR INSECTS.
- 6. PROVIDE SUPPLEMENTAL WATERING DURING 1-3



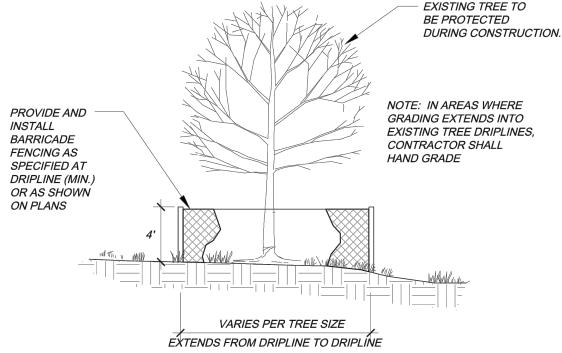

TRUNK. FOR 15" CALIPER TREE (SEE EXAMPLE)

LIMITATIONS OF ROOT ZONE DISTURBANCE:

ROOT ZONE DISTURBANCE WITHIN THE DRIP LINE SHALL BE LIMITED TO ONE SIDE OF THE TRUNK OF TREES TO BE PRESERVED. MINIMUM DISTANCE BETWEEN THE TRUNK AND THE DISTURBANCE SHALL BE EQUAL TO 1/2 OF THE TREE'S DIAMETER CONVERTED TO FEET. (FOR EXAMPLE, FOR A TREE WITH A 15" DIAMETER TRUNK, THE DISTURBANCE CAN NOT BE CLOSER THAN 7.5 FEET FROM THE

#### REQUIRED TREATMENTS:

- 1. APPLY PREVENTATIVE SPRAY FOR MOUNTAIN PINE BEETLE (MPB) AND IPS TO
- PONDEROSA, AUSTRIAN & SCOTCH PINES. TREAT ALL BARK SURFACES. INCLUDING TOP BRANCHES. 2. IF DISTURBANCE LEAVES A CUT SLOPE WITHIN THE DRIPLINE, IMMEDIATELY APPLY MULCH AND WATER.
- 3. APPLY 3"-5" OF ORGANIC MULCH OVER THE AREA WITHIN THE DRIPLINE
- 4. EVERY 1-2 WEEKS, APPLY 50-100 GALLONS OF SUPPLEMENTAL WATER.
- 5. PROVIDE SUPPLEMENTAL WATER DURING 1-3 WINTERS
- 6. REGULARLY EVALUATE TREE TO DETERMINE IF TREE IS LEANING OR IF BRANCHES / LEAVES ARE AFFECTED BY ROOT LOSS.
- 7. INSPECT TREE 2-3 TIMES PER YEAR FOR WATER NEEDS AND MONITOR FOR INSECTS.
- 8. INSTALL STAKING OR SUPPORT FOR SMALLER

TREE PRESERVATION MEASURES — 2 SIDES

AREA OF ROOT ZONE DISTURBANCE

- LIMIT OF ROOT DISTURBANCE



			EXTENDS FR
2	TREE	PROTECTION	FENCING
S	SCALE: NOT TO	) SCALE	

Print Date: 2/18/2022 4:24:38 PM				Sheet Revisions	
File Name: _Sheets — Tree Mitigation.dwg			Date	Comments	Initials
Horizontal Scale:	Vertical Scale:	R-X	Dute	Comments	IIIIIIIII
associates, inc.	2953 S Peoria St., #101 Aurora, CO 80014 <b>Phone:</b> 303.770.7201 <b>Fax:</b> 303.770.7132				




DEPARTMENT OF PUBLIC WORKS


15151 E. ALAMEDA PARKWAY AURORA, CO 80012 PHONE: (303) 739-7300

	As Constructed	NINE MILE PEDESTRIAN BRIDGE SOUTH PLAZA (RTD SITE)				Project Number
	No Revisions:	` ,			Federal Aid No. STU-M055-056	
Ī	Revised:	Designer:	WJP	Structure		CDOT Sub-Account No. 23594
ł		Detailer:	WJP	Numbers		
	Void:	Sheet Subset:	TREE MIT.	Subset Sheets:	TM-2 of 2	Sheet Number

CONSTRUCTION

NOT FOR

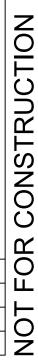

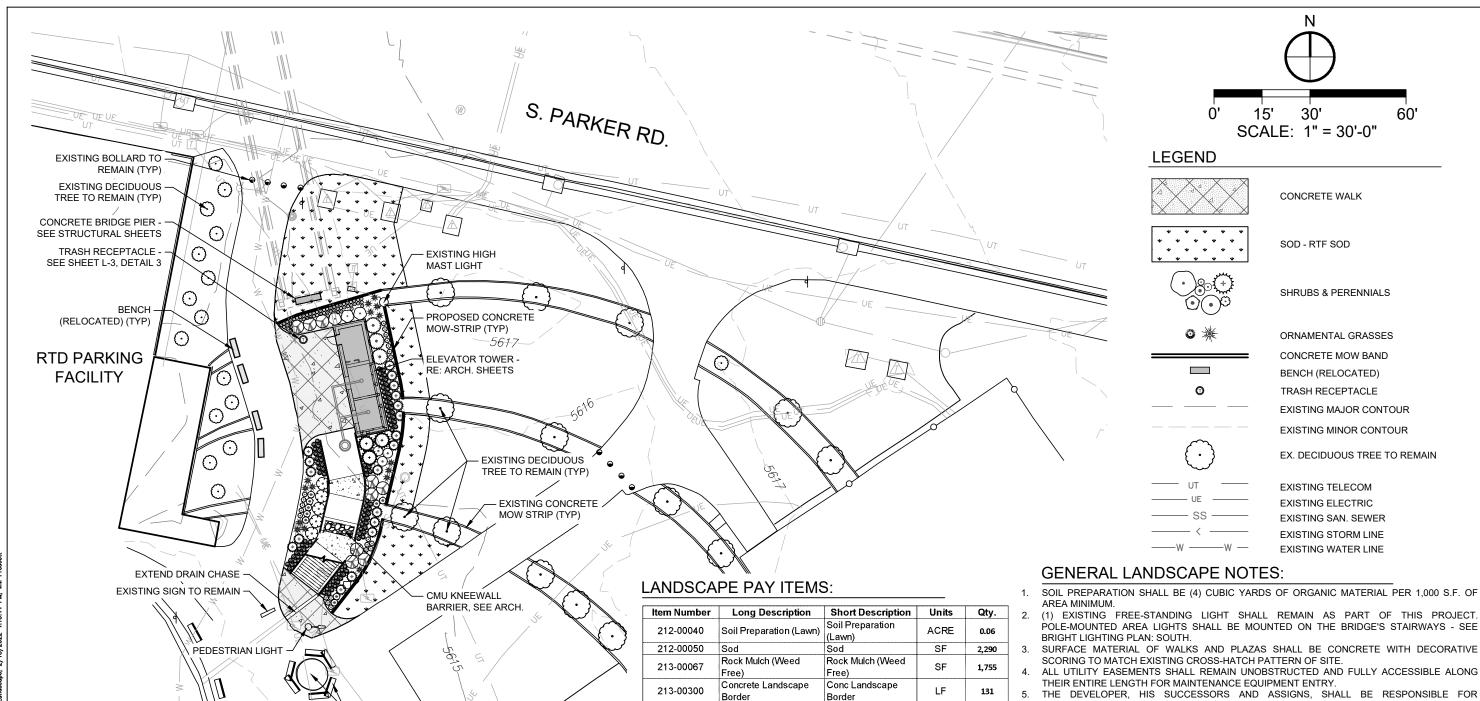


- - POLE-MOUNTED AREA LIGHTS SHALL BE MOUNTED ON THE BRIDGE'S STAIRWAYS SEE

  - INSTALLATION, MAINTENANCE, AND REPLACEMENT OF ALL LANDSCAPING MATERIALS SHOWN OR INDICATED ON THE APPROVED SITE PLAN OR LANDSCAPE PLAN ON FILE IN THE PLANNING DEPARTMENT. ALL LANDSCAPING WILL BE INSTALLED AS DELINEATED ON THE PLAN, PRIOR TO ISSUANCE OF CERTIFICATES OF OCCUPANCY.
  - ALL LANDSCAPED AREAS AND PLANT MATERIAL, EXCEPT FOR NON-IRRIGATED NATIVE, RESTORATIVE, AND DRYLAND GRASS AREAS THAT COMPLY WITH REQUIREMENTS FOUND IN SEC. 146-1429 AND/OR SEC. 146-1435 MUST BE WATERED BY AN AUTOMATIC UNDERGROUND IRRIGATION SYSTEM. IRRIGATION SYSTEM DESIGN, INSTALLATION, AND MAINTENANCE SHALL CONFORM TO REQUIREMENTS FOUND IN THE CITY OF AURORA IRRIGATION ORDINANCE.
  - A 5' CLEAR SPACE SHALL BE MAINTAINED AROUND THE CIRCUMFERENCE OF PROPOSED AND EXISTING FIRE HYDRANTS.
- MULCHING FOR SHRUB BEDS TO BE RED CEDAR MULCH OR EQUAL AT MIN. 3" DEEP.

ה ו	Print Date: 2/18/2022 4:15:44 PM		
Ę	File Name: _Sheets - Landscape.dwg		D-1-
20	Horizontal Scale: 1" = 30' Vertical Scale: 1" = 30'	(R-X)	Date
2	2953 S Peoria St., #101		
3	Aurora, CO 80014 Phone: 303.770.7201		
5	Fax: 303.770.7132		
_			

ow what's below.

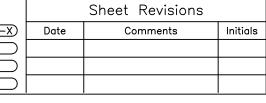

EXISTING BENCHES &

CLOCK TO REMAIN

# DEPARTMENT OF PUBLIC WORKS

Landscape

(Gal)

Ft)(B-B)

Evergreen Tree (8 Foot) Evergreen Tree (8

Maintenance

Deciduous Shrub (5

Evergreen Shrub (3

Perennials (1 Gal)

Trash Receptacle

LS

EACH

EACH

EACH

**EACH** 

EACH

23

3

19

211

1

15151 E. ALAMEDA PARKWAY AURORA, CO 80012 PHONE: (303) 739-7300

Landscape

Mainten<u>ance</u>

Deciduous Shrub (5

Gallon Container)

(Ball and Burlap)

Gallon Container)

Trash Receptacle

Container)

Evergreen Shrub (3

Perennials (1 Gallon

214-00000

214-00350


214-00508

214-00630

214-00910

622-00350

S	As Constructed	NINE MILE PEDESTRIAN BRIDGE SOUTH PLAZA (RTD SITE) OVERALL LANDSCAPE PLAN				Project Number	
	No Revisions:					Federal Aid No. STU-M055-056	
	Revised:	Designer:	WJP	Structure			CDOT Sub-Account No. 23594
		Detailer:	WJP	Numbers			
	Void:	Sheet Subset:	LANDSCAPE	Subset Sh	eets:	L1 of 4	Sheet Number

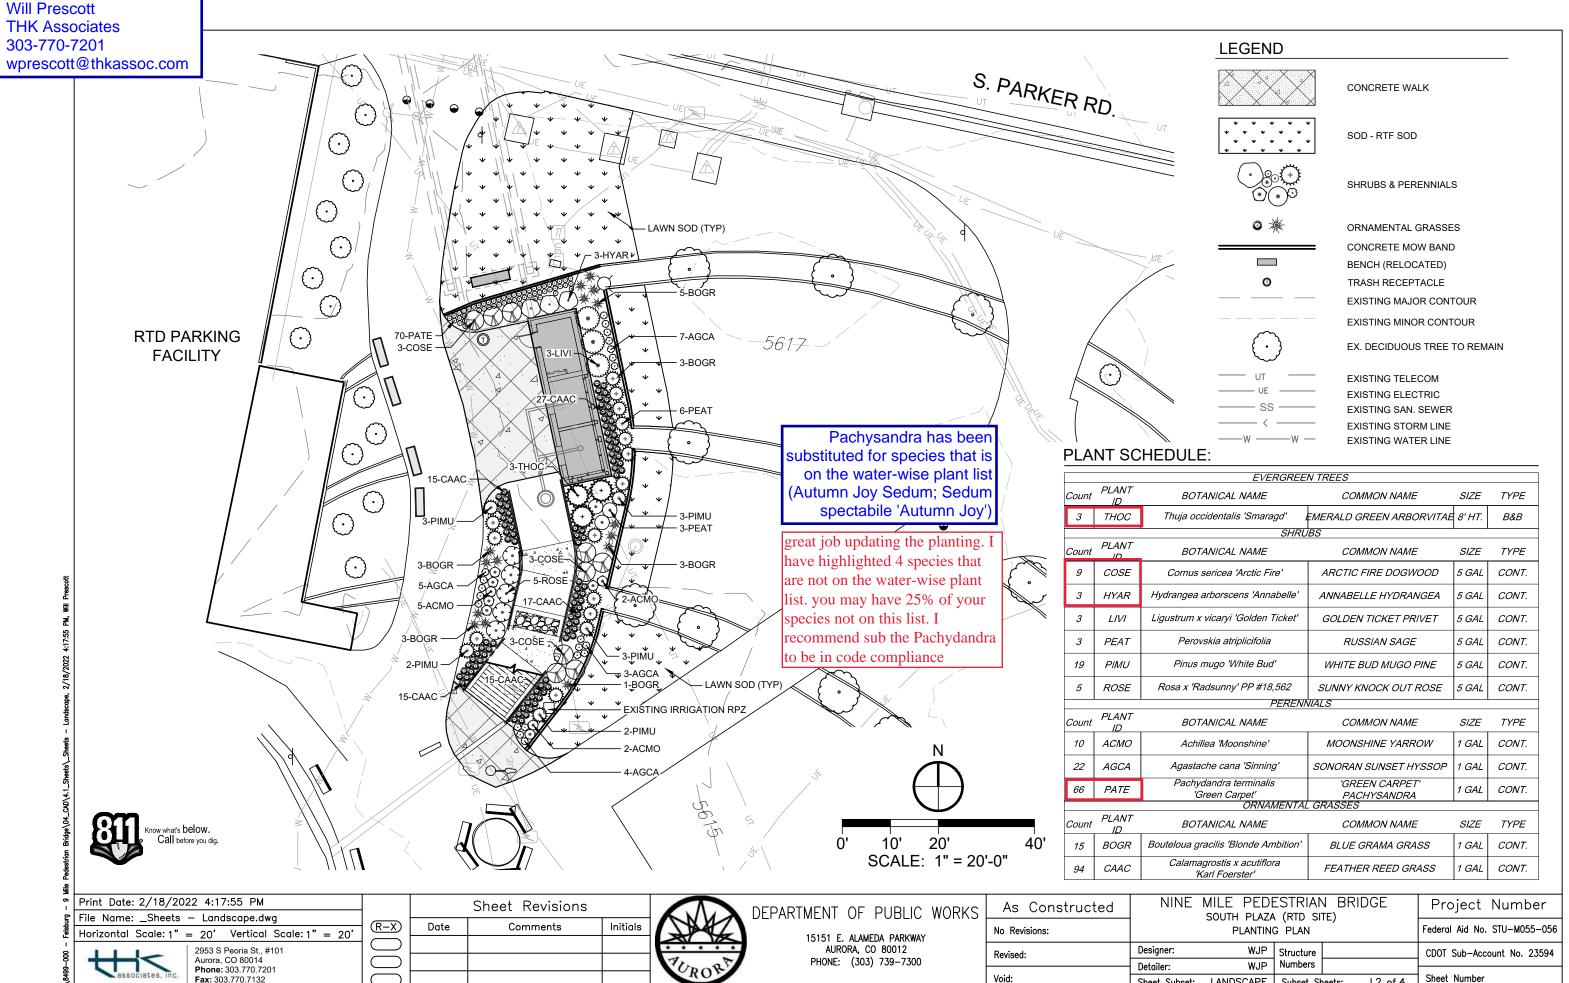

Void:


CONSTRUCTION OR NOT

Sheet Number


L2 of 4

Sheet Subset: LANDSCAPE | Subset Sheets:



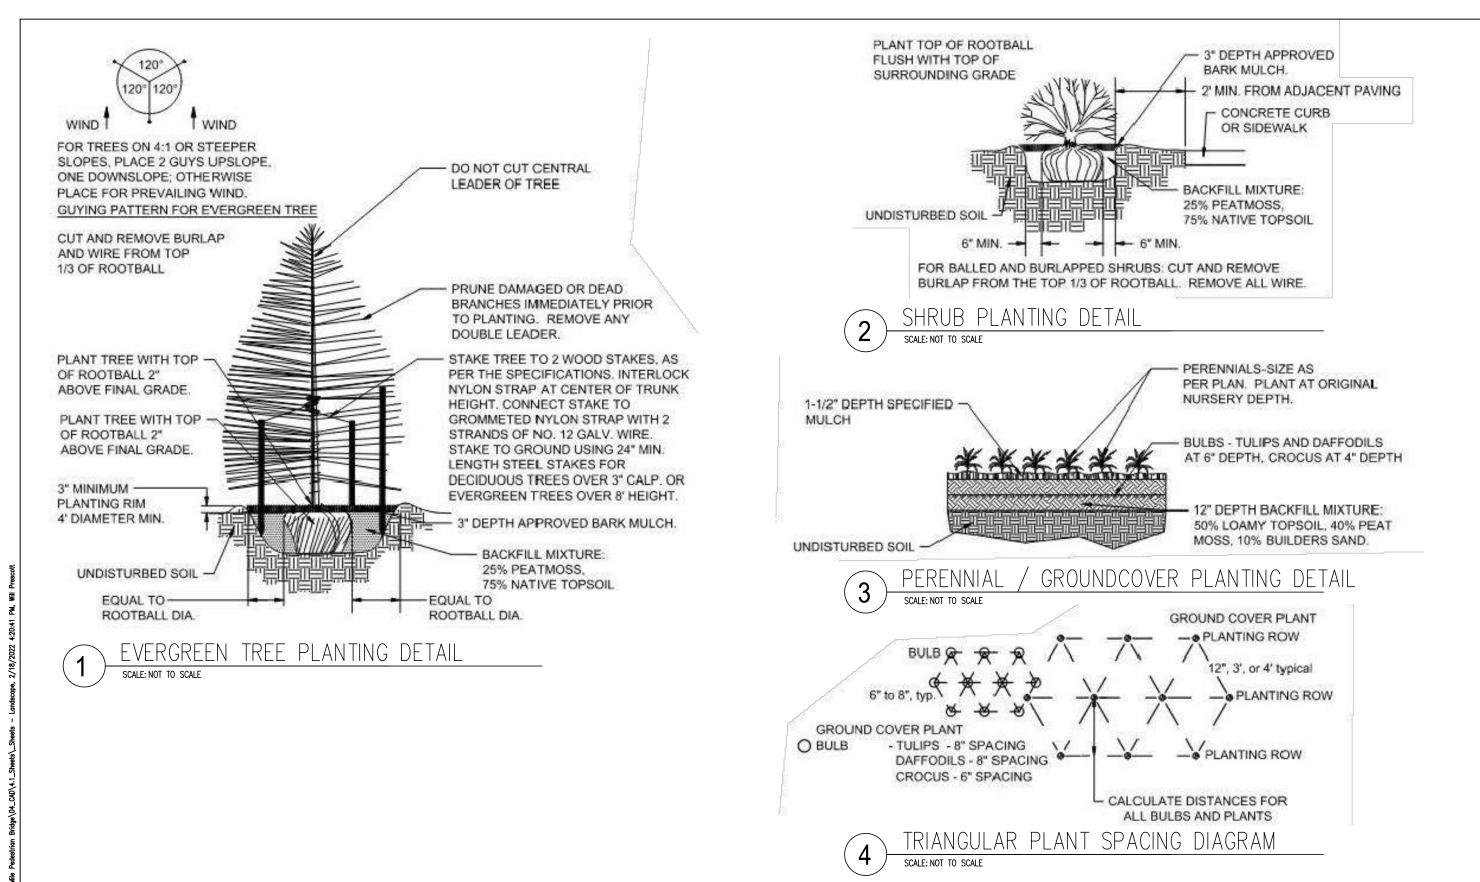


Print Date: 2/18/2022 4:20:41 PM							
File Name: _Sheets — Landscape.dwg							
Horizontal Scale: 1" = 20' Vertical Scale: 1" = 20'							
2953 S Peoria St., #101 Aurora, CO 80014 Phone: 303.770.7201 Fax: 303.770.7132							

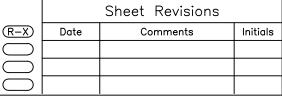





/ \(\ \ \ \ \ \ \ \ \ \ \ \ \ \ \ \ \ \	O1	•	ODLIO	110111
15151 E.	ALAM	ED/	A PARKWA	Y
AURO	DRA, C	0	80012	
PHONE:	(303	) 7	739-7300	


(S	As Constructed	NINE MILE PEDESTRIAN BRIDGE SOUTH PLAZA (RTD SITE)			Project Number		
	No Revisions:	LANDSCAPE DETAILS				Federal Aid No. STU-M055-056	
	Revised:	Designer:		Structure			CDOT Sub-Account No. 23594
		Detailer:	WJP	Numbers			
	Void:	Sheet Subset:	LANDSCAPE	Subset Sh	eets:	L3 of 4	Sheet Number

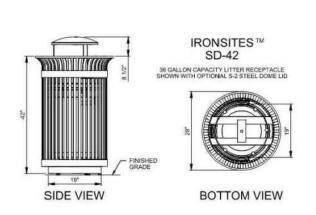

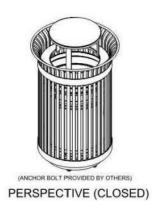

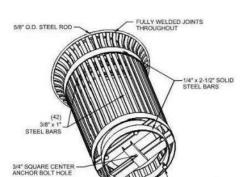

**UNDER VIEW** 

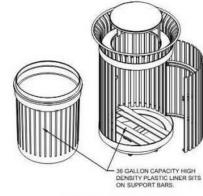


PERSPECTIVE (OPEN)



SS. ANCHOR BOLTS, -WASHERS, AND LOCK WASHERS

TRASH RECEPTACLE DETAIL


SCALE: NOT TO SCALE

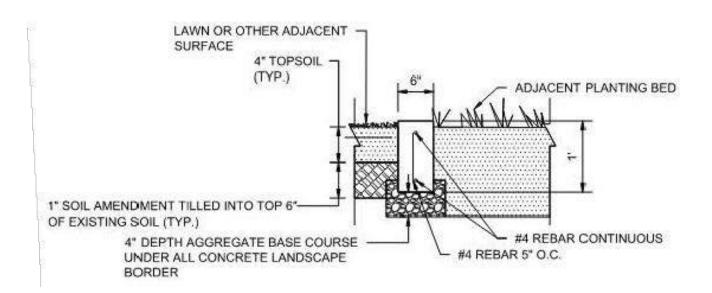


2 CONCRETE MOW STRIP DETAIL

SCALE: NOT TO SCALE



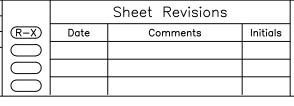

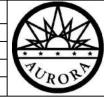

DEPARTMENT OF PUBLIC WORKS

15151 E. ALAMEDA PARKWAY AURORA, CO 80012 PHONE: (303) 739-7300

								R CONSTRUCTION
S	As Constructed	NINE	MILE PEDE SOUTH PLAZA	ESTRIAN		GE	Project Number	] [
	No Revisions:		LANDSCAPE		_/		Federal Aid No. STU-M055-05	6 L
	Revised:	Designer:	WJP	Structure Numbers			CDOT Sub-Account No. 23594	
	Void:	Detailer: Sheet Subset:	WJP LANDSCAPE	Subset She	eets:	L4 of 4	Sheet Number	



CDOT Sub-Account No. 23594

Sheet Number


WJP

Detailer:

Sheet Subset:

Numbers

IRRIGATION | Subset Sheets: IR-1 of 7

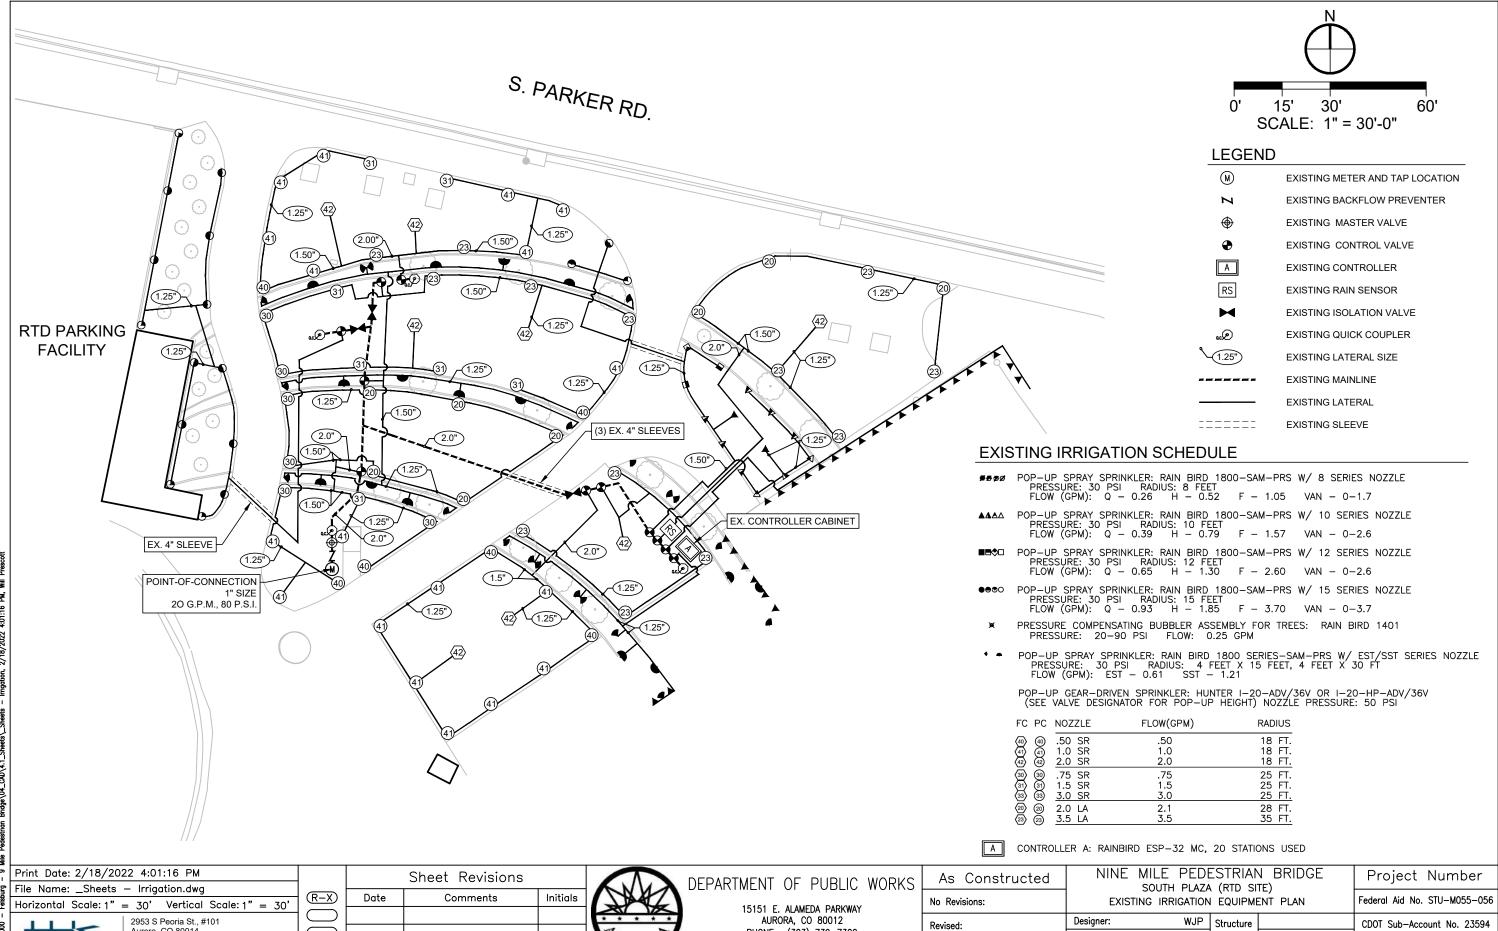

Aurora, CO 80014


Fax: 303.770.7132

Phone: 303.770.7201


Revised:

Void:

PHONE: (303) 739-7300

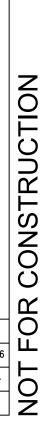


Sheet Number

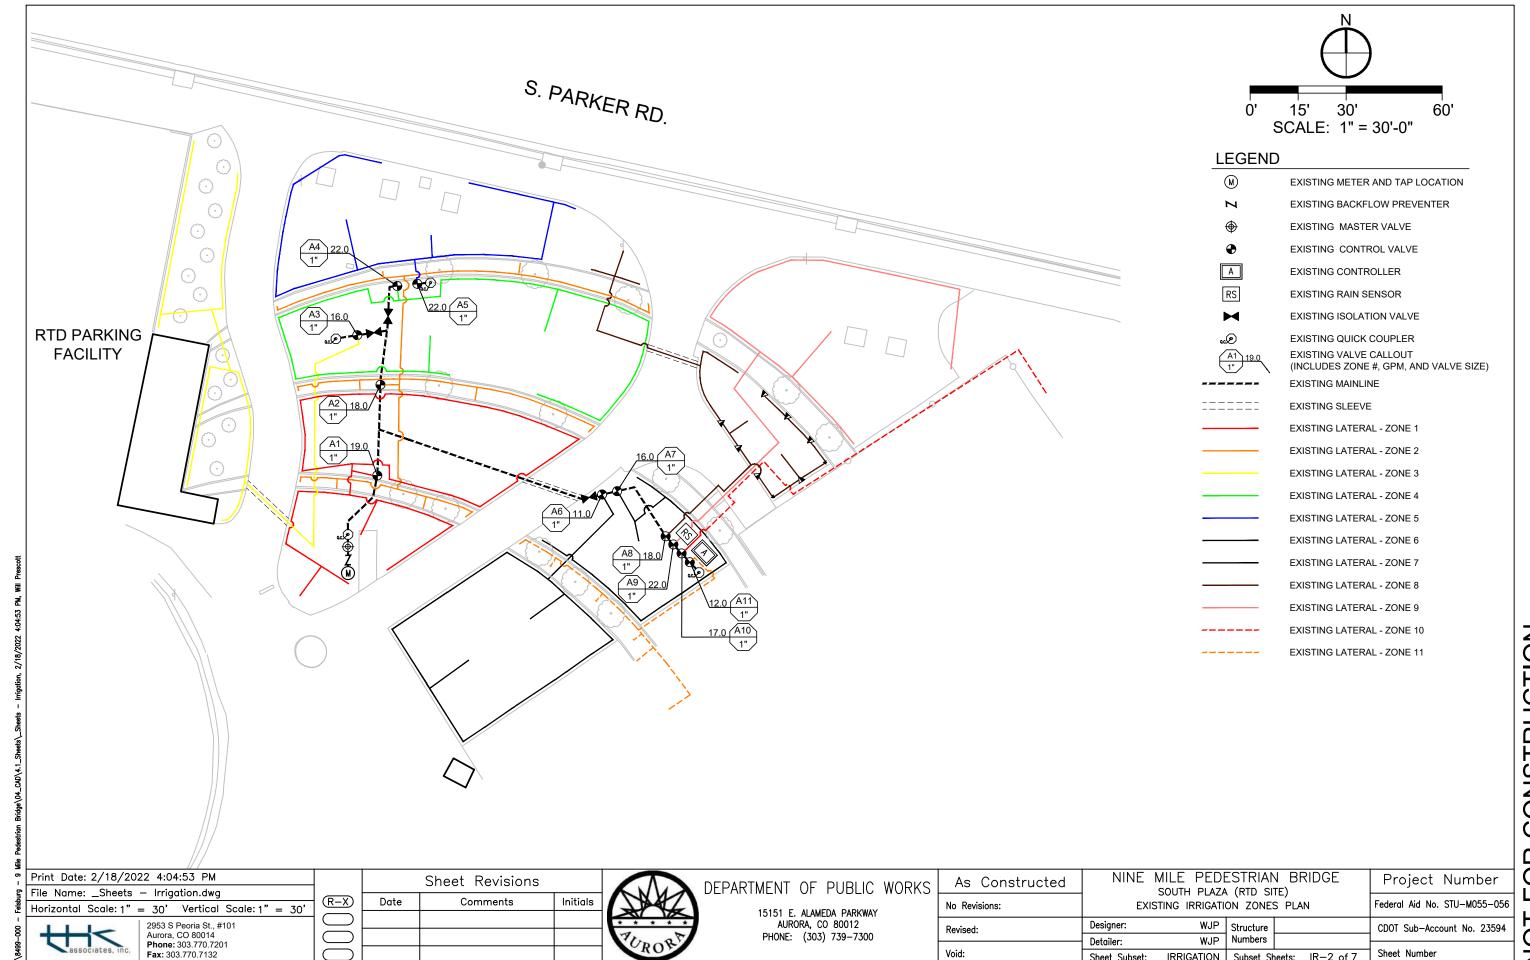

Void:

Sheet Subset:

IRRIGATION | Subset Sheets: IR-2 of 7

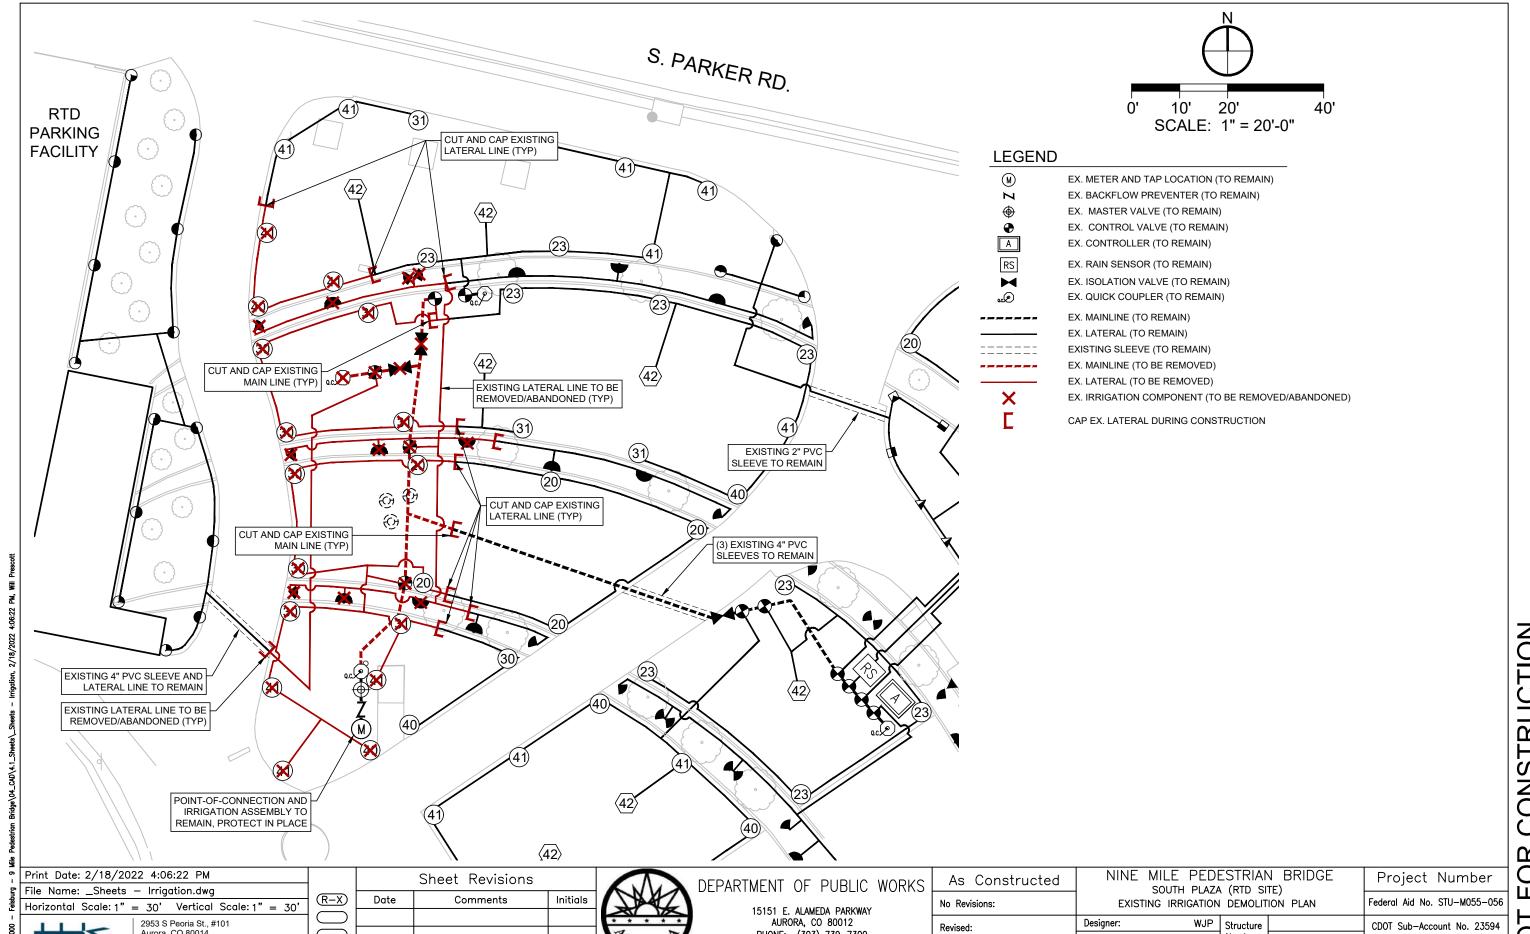

PHONE: (303) 739-7300

Aurora, CO 80014

Phone: 303.770.7201 Fax: 303.770.7132

Revised:

Void:

WJP

Detailer:

Sheet Subset:


Numbers


IRRIGATION | Subset Sheets: IR-3 of 7

CONSTRUCTION OR NOT

Sheet Number



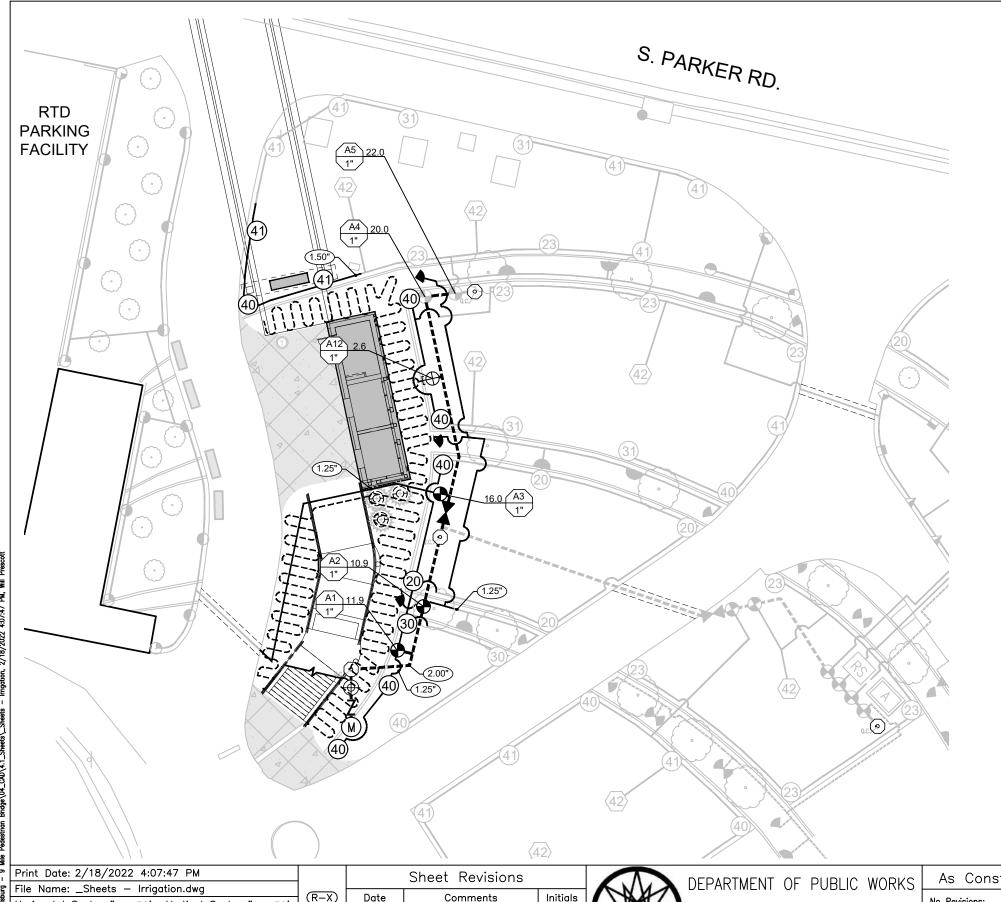

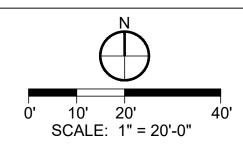

# LEGEND

И

€;

 $\mathbb{N}$ EX. METER AND TAP LOCATION (TO REMAIN)

EX. BACKFLOW PREVENTER (TO REMAIN) EX. MASTER VALVE (TO REMAIN)

**(** EX. CONTROL VALVE (TO REMAIN)

EX. CONTROLLER (TO REMAIN)

EX. RAIN SENSOR (TO REMAIN)

ISOLATION VALVE 0.0.0 QUICK COUPLER

> EX. MAINLINE (TO REMAIN) EX. LATERAL (TO REMAIN)

> > PROPOSED MAINLINE

PROPOSED LATERAL

PROPOSED DRIP LINE

ŧ⊕ DRIP ZONE VALVE

EX. GEAR DRIVEN SPRINKLER (TO REMAIN - SEE EX. SCHEDULE)

TREE DRIPPER RING

PROPOSED GEAR DRIVEN SPRINKLER (SEE PROP. SCHEDULE) 40

> PROPOSED POP-UP SPRAY SPRINKLER (SEE PROP. SCHEDULE)

# **IRRIGATION PAY ITEMS:**

Item Number	Long Description	Short Description	Units	Qty.
214-00010	Temporary Irrigation	Temp Irrigation	LS	1
623-00162	Drip Emitter Tubing	Drip Emit Tubing	LF	950
623-00164	Drip Emitter	Drip Emit	EACH	304
623-00165	Emitter Valve Assembly	Emit Valve Assembly	EACH	1
623-00205	4 Inch Pop-Up Spray Sprinkler	4 In Pop-Up Spray Spr	EACH	10
623-00600	1-1/2 Inch Plastic Pipe	1-1/2 In Plastic Pipe	LF	45
623-00601	1 Inch Plastic Pipe	1-1/2 In Plastic Pipe	LF	116
623-00602	2 Inch Plastic Pipe	1-1/2 In Plastic Pipe	LF	100
623-04008	1 Inch Quick- Coupler Valve	1 In Quick-Coupler	EACH	1

5 ∣							
6	Print Date: 2/18/2022 4:07:47 PM		Sheet Revisions				
ē	File Name: _Sheets — Irrigation.dwg	(R-X)		1	$\neg$	_	
불	Horizontal Scale: 1" = 30' Vertical Scale: 1" = 30'		Date	Comments	_	ln'	
	2953 S Peoria St., #101						
\8499-000	Aurora, CO 80014 Phone: 303.770.7201						
	Fax: 303.770.7201						
ا نــٰ			1	J.	- 1		




15151 E. ALAMEDA PARKWAY AURORA, CO 80012 PHONE: (303) 739-7300


	As Constructed	NINE MILE PEDESTRIAN BRIDGE south plaza (rtd site) proposed irrigation plan				1 11112 112231111111 211122   1100000 111		Project Number
	No Revisions:					Federal Aid No. STU-M055-056		
	Revised:	Designer:	WJP	Structure		CDOT Sub-Account No. 23594		
ł		Detailer:	WJP	Numbers				
	Void:	Sheet Subset:	IRRIGATION	Subset Shee	ts: IR-4 of 7	Sheet Number		


- 2. CONTRACTOR IS TO COORDINATE WITH CLIENT AND MAINTENANCE STAFF FOR THE CONNECTION AND INSTALLATION OF ALL REQUIRED IRRIGATION EQUIPMENT THAT IS NOT CALLED OUT ON PLANS.
- 3. CONTRACTOR SHALL TEST THE EXISTING IRRIGATION SYSTEM PRESSURE DOWNSTREAM OF THE BACKFLOW PREVENTER. IF PRESSURE REGULATION FOR THE ENTIRE IRRIGATION SYSTEM IS REQUIRED, UTILIZE THE EQUIPMENT SHOWN IN THE IRRIGATION SCHEDULE. IF PRESSURE REGULATION FOR THE ENTIRE IRRIGATION SYSTEM IS NOT REQUIRED, NO EQUIPMENT SHALL BE INSTALLED. CONTRACTOR TO SUBMIT RESULTS OF PRESSURE TEST TO THE OWNER / ENGINEER.
- 4. ANY DRIP IRRIGATION VALVES NEEDED FOR CONTRACTOR INSTALLATION WILL REQUIRE 30 PSI AND SHALL BE A RAINBIRD XCZ-LF-100-PRF (0.20-10 GPM) WITH A PRECIPITATION RATE OF 0.50 INCHES PER HOUR.
- 5. FINAL IRRIGATION LAYOUT WILL NOT EXCEED A MAXIMUM IRRIGATION TIME OF 16 HOURS THREE DAYS A WEEK.
- 6. NO WORK SHALL OCCUR UNTIL ALL EXISTING UNDERGROUND UTILITIES HAVE BEEN LOCATED AND MARKED. CALL LOCAL UTILITY LOCATING SERVICE AT 719-448-4800 AT LEAST 48 HOURS PRIOR TO BEGINNING CONSTRUCTION. IRRIGATION WORK SHALL NOT BEGIN UNTIL FINAL GRADE HAS BEEN APPROVED.
- 7. NO DRIP EMITTERS SHALL BE INSTALLED UNTIL ALL PLANT MATERIAL HAS BEEN INSTALLED.
- 8. ALL DRAWINGS ARE DIAGRAMMATIC IN NATURE. IN SOME CASES, LINES OR EQUIPMENT ARE SHOWN OVER WALKS OR DRIVES. THIS IS FOR CLARITY ONLY.
- 9. FINAL IRRIGATION DESIGN SHALL BE CAPABLE OF SUPPLYING A SUFFICIENT NUMBER OF INCHES OF WATER PER WEEK TO THE TOTAL IRRIGATED AREA IN ORDER TO MAINTAIN THE HEALTH OF ALL PLANTINGS.
- 10. THE IRRIGATION CONTRACTOR SHALL NOT INSTALL THE IRRIGATION SYSTEM WHEN IT IS OBVIOUS IN THE FIELD THAT OBSTRUCTIONS OR GRADE DIFFERENCES EXIST THAT MIGHT NOT HAVE BEEN CONSIDERED IN THE IRRIGATION DESIGN OR IF DISCREPANCIES IN CONSTRUCTION DETAILS, LEGEND NOTES, OR SPECIFICATIONS ARE DISCOVERED. ALL SUCH OBSTRUCTIONS OR DISCREPANCIES SHALL BE IMMEDIATELY BROUGHT TO THE ATTENTION OF THE ENGINEER.
- 11. THE IRRIGATION CONTRACTOR SHALL BE RESPONSIBLE FOR MAKING THE ELECTRICAL CONNECTION TO THE EXISTING CONTROLLER AND WIRING AS NEEDED TO ALL VALVES.
- 13. DRIP EMITTERS ARE TO BE INSTALLED AS FOLLOWS:
  - 13.1 TREES: THREE (3) 0.5 GPH EMITTERS
  - 13.2 SHRUBS: TWO (2) 0.5 GPH EMITTERS.
  - 13.3 GRASSES AND PERENNIALS: ONE (1) 0.5 GPH EMITTER
- 14. ROCK MULCH SHALL BE PLACED AFTER EMITTERS ARE INSTALLED.
- 15. ALL DRIP LINE ENDS SHALL INCLUDE END CAPS.
- 17. EXCESS DIRT GENERATED BY TRENCHING OPERATIONS SHALL BE DISPOSED OF BY CONTRACTOR AT OFF—SITE LOCATION AT NO ADDITIONAL COST TO OWNER.
- 19. CONTRACTOR SHALL REPLACE AT HIS EXPENSE ANY HEAD DAMAGED OR BROKEN DUE TO CONSTRUCTION ACTIVITIES THAT ARE NOT SHOWN ON THESE PLANS FOR REPAIR, REPLACEMENT, OR RELOCATION.

### PROPOSED IRRIGATION EQUIPMENT SCHEDULE

SYMBOL	<u>EQUIPMENT</u>	DESCRIPTION
© <sub>ec</sub>	QUICK COUPLER	RAINBIRD 5 LRC
	Q.C. KEY	RAINBIRD 4-K
⊕i	DRIP ZONE CONTROL KIT	RAINBIRD DRIP VALVE RAINBIRD CZ-LF-100-PRF (0.20 - 10 GPM)
M	2" GATE VALVE	BRASS GATE VALVE
	2" MAINLINE	CL 200 PVC
	LATERAL LINE	CL 80 PVC
	DRIP IRRIGATION SUPPLY DRIP IRRIGATION EMITTER	RAINBIRD XFD500 WITH MDCFCAP
	DRIP IRRIGATION DISTRIBUTION	RAINBIRD XB-T-05-PC RAINBIRD XQ-1000-B
20	POP-UP ROTOR SPRINKLER	HUNTER I-20-ADV/36V OR I-20-HP-ADV/36V PC - 2.0 LA NOZZLE, 28 FT RADIUS
30	POP-UP ROTOR SPRINKLER	HUNTER I-20-ADV/36V OR I-20-HP-ADV/36V PC75 SR NOZZLE, 25 FT RADIUS
40	POP-UP ROTOR SPRINKLER	HUNTER I-20-ADV/36V OR I-20-HP-ADV/36V PC - 1.0 SR NOZZLE, 18 FT RADIUS
(41)	POP-UP ROTOR SPRINKLER	HUNTER I-20-ADV/36V OR I-20-HP-ADV/36V PC - 0.5 SR NOZZLE, 18 FT RADIUS
•	POP-UP SPRAY SPRINKLER	RAINBIRD 1800 SERIES-SAM-PRS W/ EST SERIES NOZZLE 4 FEET X 30 FT RADIUS

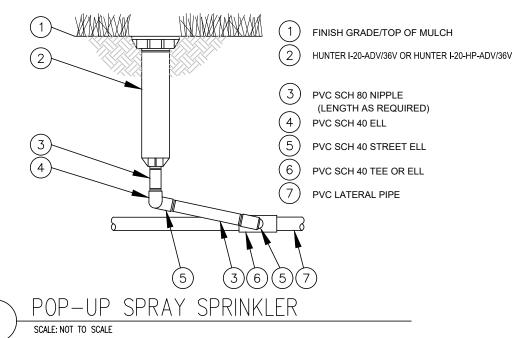

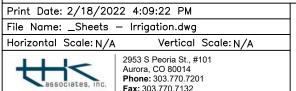

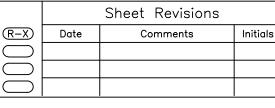




DEPARTMENT OF PUBLIC WORKS


15151 E. ALAMEDA PARKWAY AURORA, CO 80012 PHONE: (303) 739-7300

As Constructed	NINE MILE PEDESTRIAN BRIDGE SOUTH PLAZA (RTD SITE) IRRIGATION NOTES AND DETAILS				Project Number	
No Revisions:					Federal Aid No. STU-M055-056	
Revised:	Designer:	WJP	_ Structure			CDOT Sub-Account No. 23594
	Detailer:	WJP				
Void:	Sheet Subset:	IRRIGATION	Subset Sh	eets:	IR-5 of 7	Sheet Number


 $\Box$ 

r -05

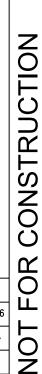


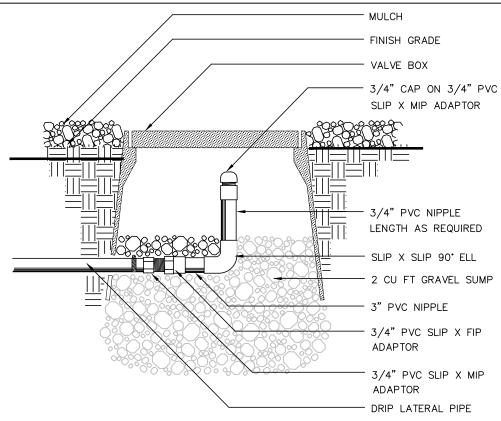


DRIP LINE END PLUG SCALE: NOT TO SCALE

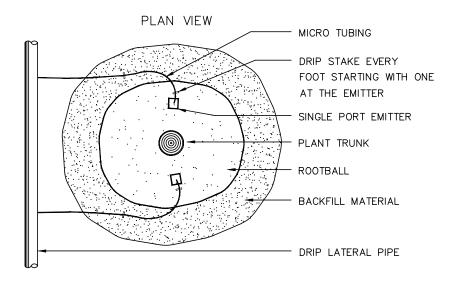

SHRUB DRIP EMITTER SCALE: NOT TO SCALE

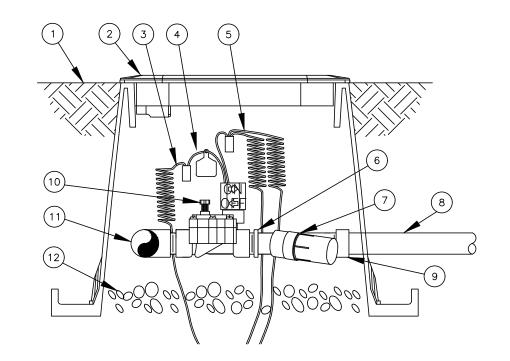

- (1) FINISH GRADE
- (2) STANDARD VALVE BOX WITH COVER:
- 3 WATERPROOF CONNECTION: RAIN BIRD DB SERIES
- (4) VALVE ID TAG
- (5) 30-INCH LINEAR LENGTH OF WIRE, COILED 1"x\frac{3}{4}" REDUCING COUPLING (INCLUDED IN XCZ-LF-100-PRF KIT)
- (6) PRESSURE REGULATING FILTER: RAIN BIRD PRF-100-RBY (INCLUDED IN XCZ-LF-100-PRF KIT
- (7) LATERAL PIPE
- (8) PVC SCH 40 FEMALE ADAPTOR OR REDUCER
- 9 REMOTE CONTROL VALVE: RAIN BIRD LFV-100 (INCLUDED IN XCZ-LF-100-PRF KIT)
- (10) PVC SCH 40 TEE OR ELL TO MANIFOLD
- (11) 3-INCH MINIMUM DEPTH OF 3/4-INCH WASHED GRAVEL
- (12) MANIFOLD PIPE AND FITTINGS

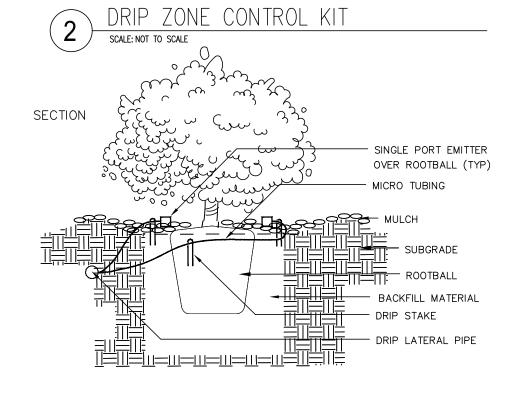

•	Print Date: 2/18/2022 4:10:36 PM			Sheet Revisions	
2	File Name: _Sheets - Irrigation.dwg				
2	Horizontal Scale: N/A Vertical Scale: N/A	R-X	Date	Comments	Initials
-	Tionzontal Codic. N/A Tortical Codic. N/A				
3	2953 S Peoria St., #101 Aurora, CO 80014 Phone: 303 770.7201				
5	Fax: 303.770.7132				



DEPARTMENT OF PUBLIC WORKS


15151 E. ALAMEDA PARKWAY AURORA, CO 80012 PHONE: (303) 739-7300

()	As Constructed	NINE MILE PEDESTRIAN BRIDGE SOUTH PLAZA (RTD SITE)			Project Number			
	No Revisions:					Federal Aid No. STU-M055-056		
	Revised:	Designer:		Structure			CDOT Sub-Account No. 23594	ĺ
		Detailer:	WJP	Numbers				ı
	Void: Sheet Subset:		IRRIGATION	Subset Sh	eets:	IR-6 of 7	Sheet Number	ĺ

- PVC DRIP MANIFOLD PIPE
- PVC SCH 40 TEE OR EL
- RAIN BIRD XF SERIES BLANK
- BARB CROSS INSERT FITTING: RAIN BIRD XFD-CROSS
- BARB TEE INSERT FITTING: RAIN BIRD XFF-TEE
- PROJECTED CANOPY LINE OF
- ON-SURFACE DRIPLINE: RAIN BIRD XFD PRIPLINE
- 8 ROOT BALL
- TIE DOWN STAKE: RAIN BIRD TDS-050 WITH BEND (QUANTITY AS REQUIRED, SEE NOTES 2-3 BELOW)
- 1. DISTANCE BETWEEN LATERAL RINGS AND EMITTER SPACING TO BE BASED ON SOIL TYPE, AND TREE CANOPY. SEE INSTALLATION SPECIFICATIONS ON RAIN BIRD WEB SITE (WWW.RAINBIRD.COM) FOR
- 2. PLACE TIE DOWN STAKES EVERY THREE FEET IN SAND, FOUR FEET IN LOAM, AND FIVE FEET IN CLAY. 3. AT FITTINGS WHERE THERE IS A CHANGE OF DIRECTION SUCH AS TEES OR ELBOWS, USE TIE-DOWN STAKES ON EACH LEG OF THE CHANGE OF DIRECTION.



RAIN BIRD XFD ON-SURFACE TREE RING

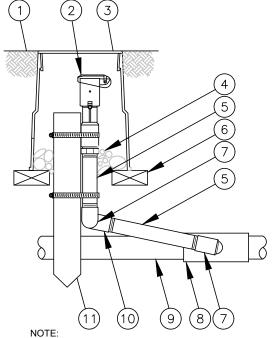

- FINISH GRADE/TOP OF MULCH
- QUICK-COUPLING VALVE: RAIN BIRD MODEL 5LRC
- VALVE BOX WITH COVER: CARSON-BROOKS MODEL 910
- 3-INCH MINIMUM DEPTH OF 3/4-INCH WASHED GRAVEL
- PVC SCH 80 NIPPLE (LENGTH AS REQUIRED)
- BRICK (1 OF 2)
- PVC SCH 40 STREET ELL
- PVC SCH 40 TEE OR ELL
- (9) PVC MAINLINE PIPE
- (10) PVC SCH 40 ELL
- 2" x 2" REDWOOD STAKE WITH STAINLESS STEEL GEAR CLAMPS OR EQUIVALENT SUPPORT SYSTEM

FURNISH FITTINGS AND PIPING NOMINALLY SIZED IDENTICAL TO NOMINAL QUICK COUPLING VALVE INLET SIZE.

QUICK COUPLING VALVE 5LRC SERIES

SCALE: NOT TO SCALE

5						
6 -	Print Date: 2/18/2022 4:13:30 PM					
£ n	File Name: _Sheets -	- Irrigation.dwg				
Felsburg	Horizontal Scale: N/A	Vertical Scale: N/A	(K-X)			
L:\8499-000 -	associates, inc.	2953 S Peoria St., #101 Aurora, CO 80014 <b>Phone:</b> 303.770.7201 <b>Fax:</b> 303.770.7132	000			



Initials

DEPARTMENT OF PUBLIC WORKS

15151 E. ALAMEDA PARKWAY AURORA, CO 80012 PHONE: (303) 739-7300

					R CONSTRUCTION
,	As Constructed	NINE MILE PED SOUTH PLAZA		Project Number	Б
	No Revisions:	IRRIGATION NOTE	Federal Aid No. STU-M055-056		
	Revised:	Designer: WJP	Structure	CDOT Sub-Account No. 23594	
	Void:	Detailer: WJP Sheet Subset: IRRIGATION	Numbers Subset Sheets: IR-7 of 7	Sheet Number	$\geqslant$
		L			_

Sheet Revisions Date Comments